


I:_2022\225H009 SHT ENGINEERING PLANNING\TASK 20 NEW EQUIPMENT BUILDING\SPEC PACKAGE SHT EQUIPMENT BUILDING\SH\CONTRACT BID DOCUMENTS\SH\ MUNICIPAL BLDG - 225H009-20.DWG

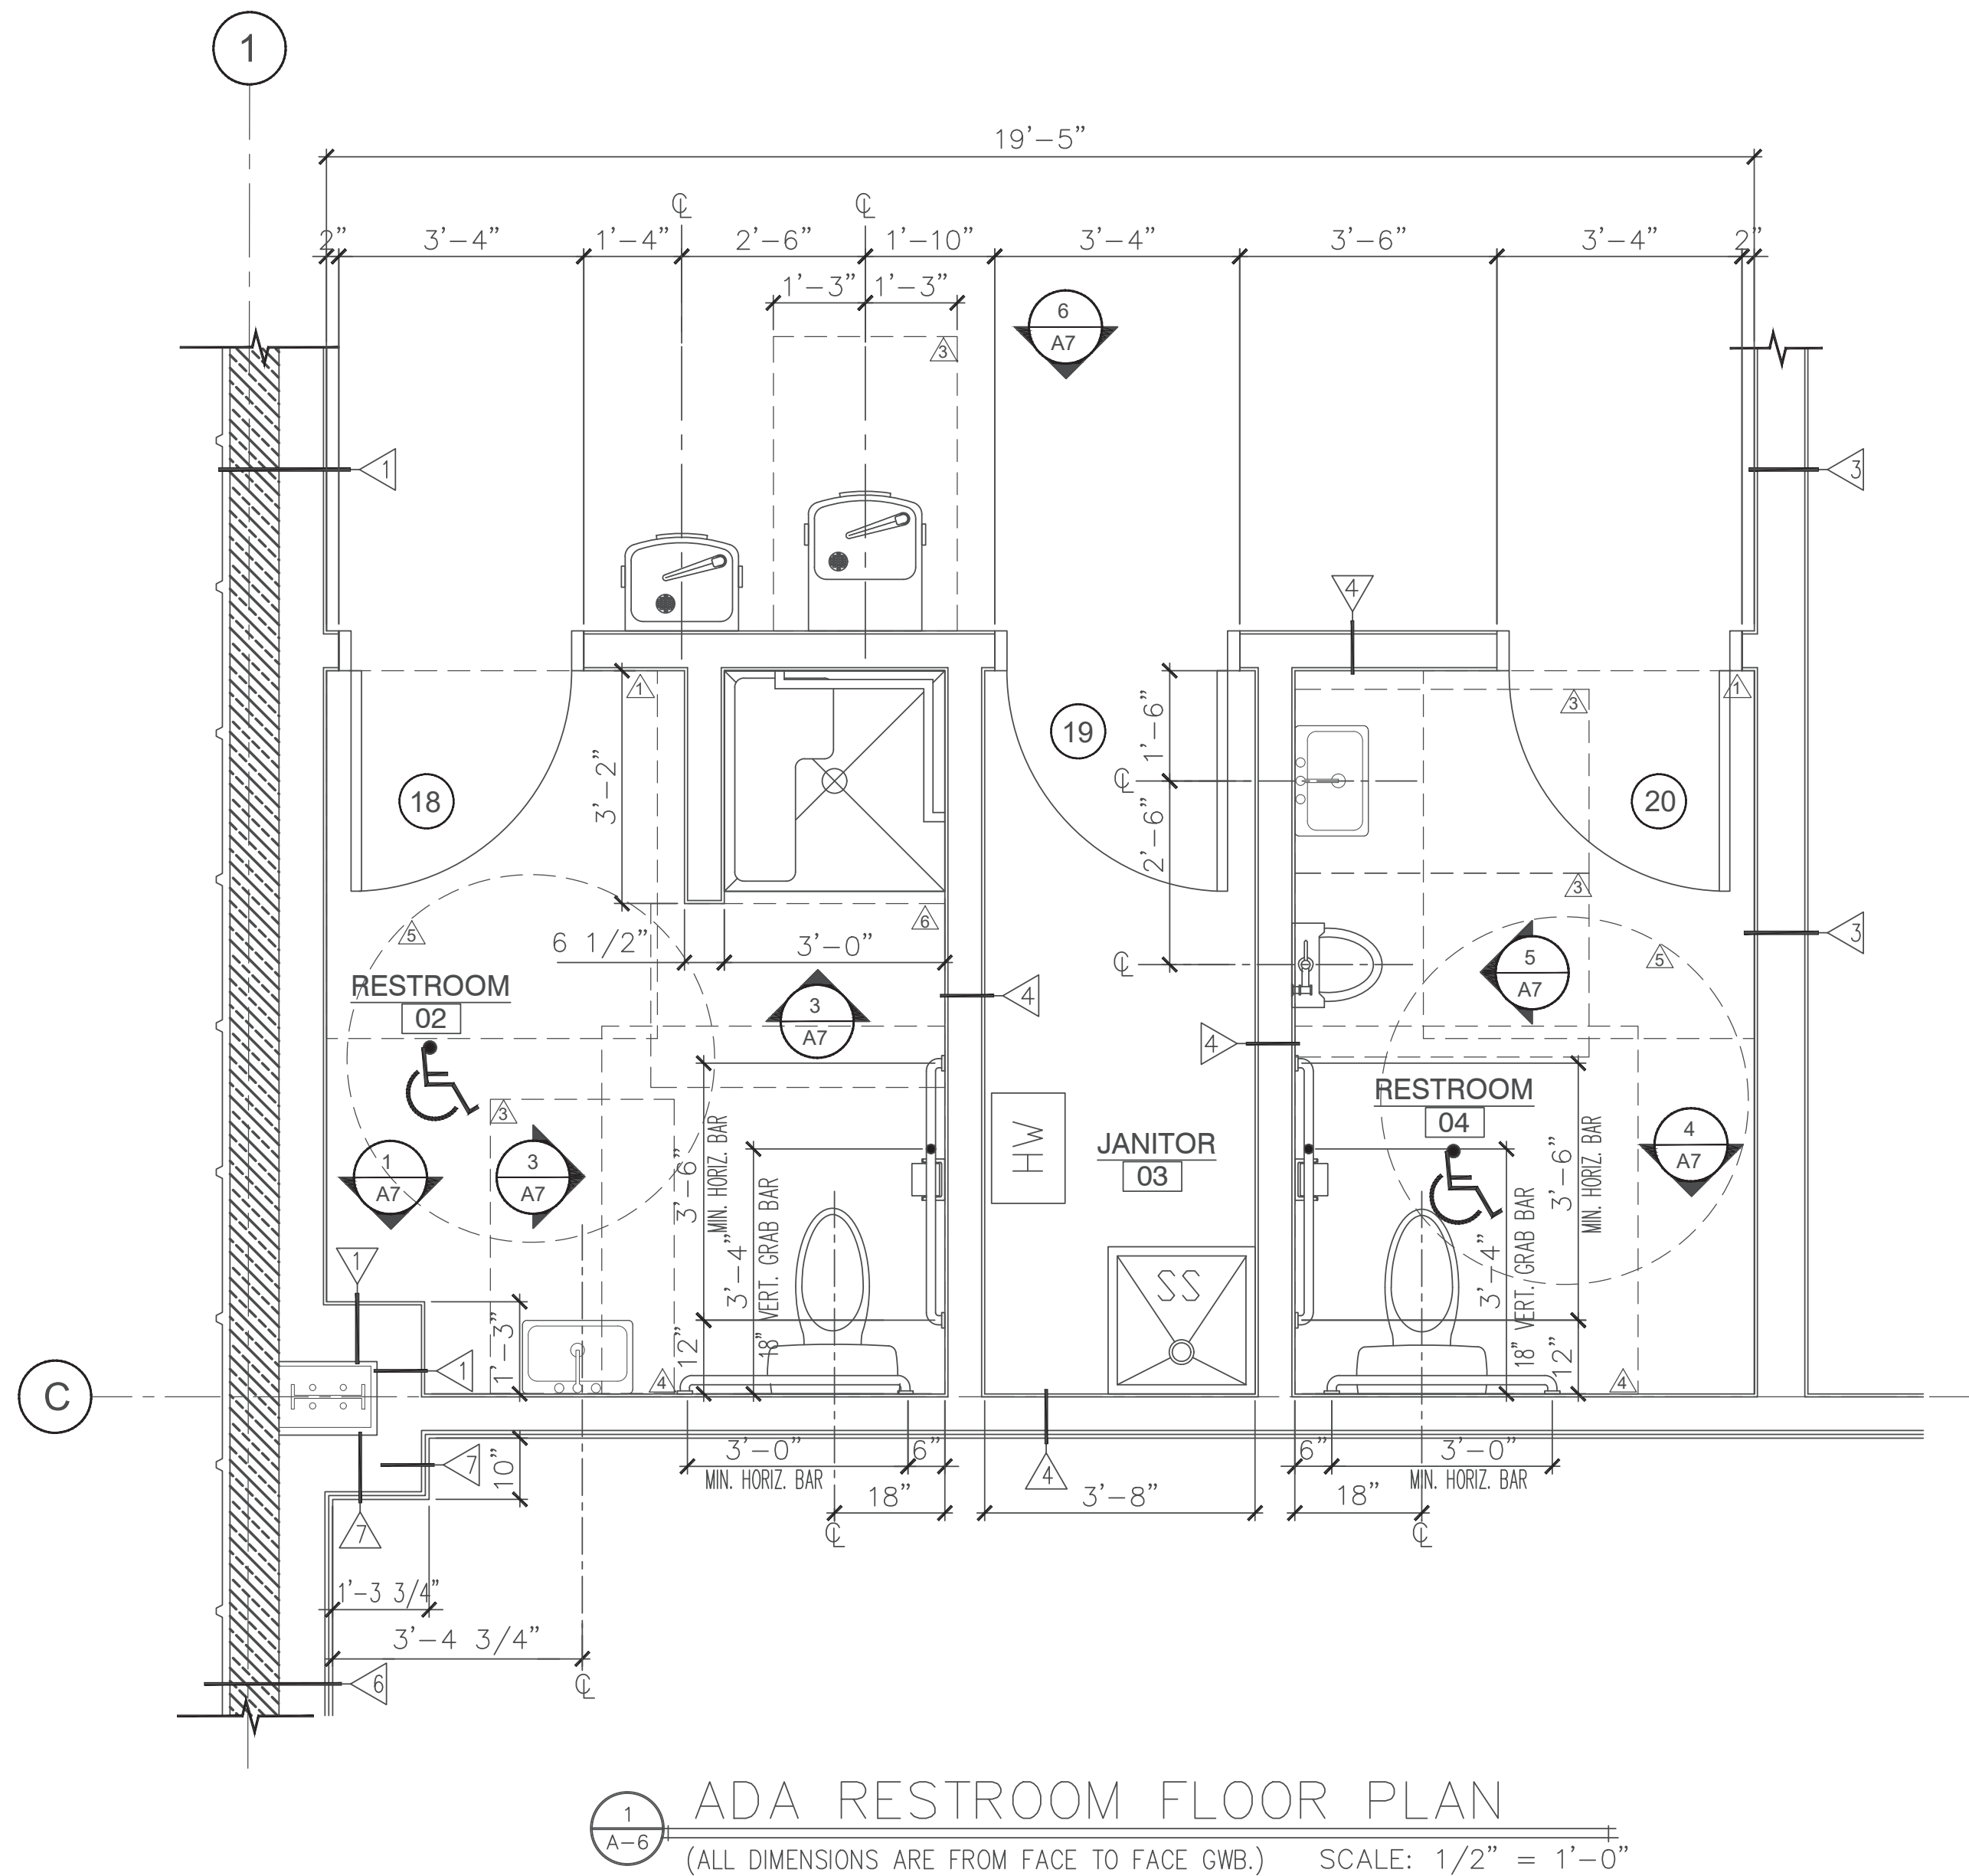

1
A-6 ADA RESTROOM FLOOR PLAN
(ALL DIMENSIONS ARE FROM FACE TO FACE GWB.) SCALE: 1/2" = 1'-0"

ADA NOTES:

- ALL NEW SANITARY AND SUPPLY LINES SHALL BE PADDED.
- FLUSH CONTROLS SHALL BE ON TRANSFER SIDE OF COMMODE.
- MAXIMUM HEIGHT OF SINK RIM SHALL BE 34" A.F.F. FOLLOWING ELEVATIONS FOR NEW SINK INSTALLATION.
- ALL GRAB BARS TO HAVE 2x10 BLOCKING IN WALL FOR ATTACHMENT.
- RESTROOM SINK TO HAVE 2x12 BLOCKING IN WALL FOR ATTACHMENT.
- FOLLOW ALL DIMENSIONS ON PLAN & ELEVATION FOR ADA COMPLIANCE AND ARE TO THE FINISH FACE OF WALL.
- ADA WATER FOUNTAINS ARE NEW.

ADA CLEARANCES:

- △ WIDTH OF DOOR (36") + 18" x 60" CLEAR FLOOR SPACE @ PULL SIDE OF DOOR.
- △ WIDTH OF DOOR (36") + 12" x 48" CLEAR FLOOR SPACE @ PUSH SIDE OF DOOR WHEN CLOSER IS PRESENT.
- △ 30" x 48" CLEAR FLOOR SPACE @ SINK, WATER FOUNTAINS & URINAL LOCATIONS.
- △ 60" x 60" CLEAR FLOOR SPACE @ FLOOR MOUNTED TOILET LOCATIONS.
- △ 5'-0" ADA DIAMETER CIRCLE
- △ 30" x 48" CLEAR FLOOR SPACE @ ADA SHOWER COMPARTMENT


MARK	WALL TYPE DESCRIPTION
1	CORRUGATED METAL PANEL ON ONE SIDE WITH WITH 8" GIRTS, NON-RATED INTERIOR BEARING PARTITIONS & 1/2" PLYWOOD ON THE OTHER SIDE OF 2x8" WOOD STUDS AT 16" O.C.
2	CORRUGATED METAL PANEL ON ONE SIDE WITH WITH 6" GIRTS, NON-RATED INTERIOR NON-BEARING PARTITIONS & 1/2" PLYWOOD ON THE OTHER SIDE OF 2x6" WOOD STUDS AT 16" O.C.
3	NON-RATED INTERIOR BEARING PARTITIONS - 2x8" WOOD STUDS @ 16" O.C. WITH 1 LAYER OF 1/2" GWB. ON BOTH SIDES. (SUBSTITUTE 1/2" PLYWOOD FOR GWB. IN ROOM #5)
4	NON-RATED INTERIOR NON-BEARING PARTITIONS - 2x6" WOOD STUDS @ 16" O.C. WITH 1 LAYER OF 1/2" GWB. ON BOTH SIDES. (SUBSTITUTE 1/2" PLYWOOD FOR GWB. IN ROOM #5)
5	NON-RATED INTERIOR BEARING PARTITIONS - 2x6" WOOD STUDS @ 16" O.C. WITH 1 LAYER OF 1/2" GWB. ON BOTH SIDES.
6	3-HOUR FIRE RATED NON-BEARING WALL - 6" STEEL STUDS, 2 1/2" FIBERGLASS INSULATION, AND 3 LAYERS OF 1/2" TYPE ULIX GWB. ON BOTH SIDES.

SYMBOL LEGEND

- 8 DOOR NUMBER
 - A WINDOW TYPE
 - 1 WALL TYPE
 - A or 1 STRUCTURAL GRID CALLOUTS
 - 1 A-4 EXTERIOR WALL SECTION
 - 1 A-5 BUILDING CROSS SECTION
- DIMENSIONS ARE STUD TO STUD

Engineer's Stamp:

I certify that to the best of my knowledge and belief this plan is true and correct and the Owner may rely upon the accuracy thereof.

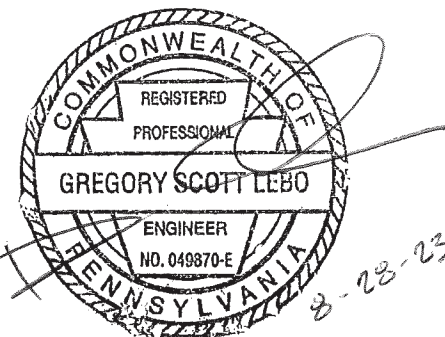

Gregory Scott Lebo, P.E. # 49870-E

NOT FOR CONSTRUCTION - ISSUED FOR BID AND PERMIT 08-21-23

RESTROOM ENLARGE DETAILS

CONSTRUCTION DRAWINGS

FOR TOWNSHIP EQUIPMENT BUILDING

SOUTHAMPTON TWP. CUMBERLAND COUNTY, PA

BREHM-LEBO ENGINEERING, INC.

CIVIL ENGINEERS • PLANNERS • SURVEYORS • STRUCTURAL ENGINEERS

40 NORTH SECOND STREET
CHAMBERSBURG, PA 17001
PH: (717) 267-1401
FAX: (717) 243-5301

17 STATE AVENUE
CARLISLE, PA 17013
PH: (717) 243-4114
FAX: (717) 243-5301



REVISION NOTES
ADDENDUM #3

NO. 1

DATE
9/14/23

Drawn By: DNF
Designed By: BSC
Checked By: GSL
File: 2022-SH-009
Date: 8/21/2023
Scale: AS NOTED
Drawing No.

A-6