
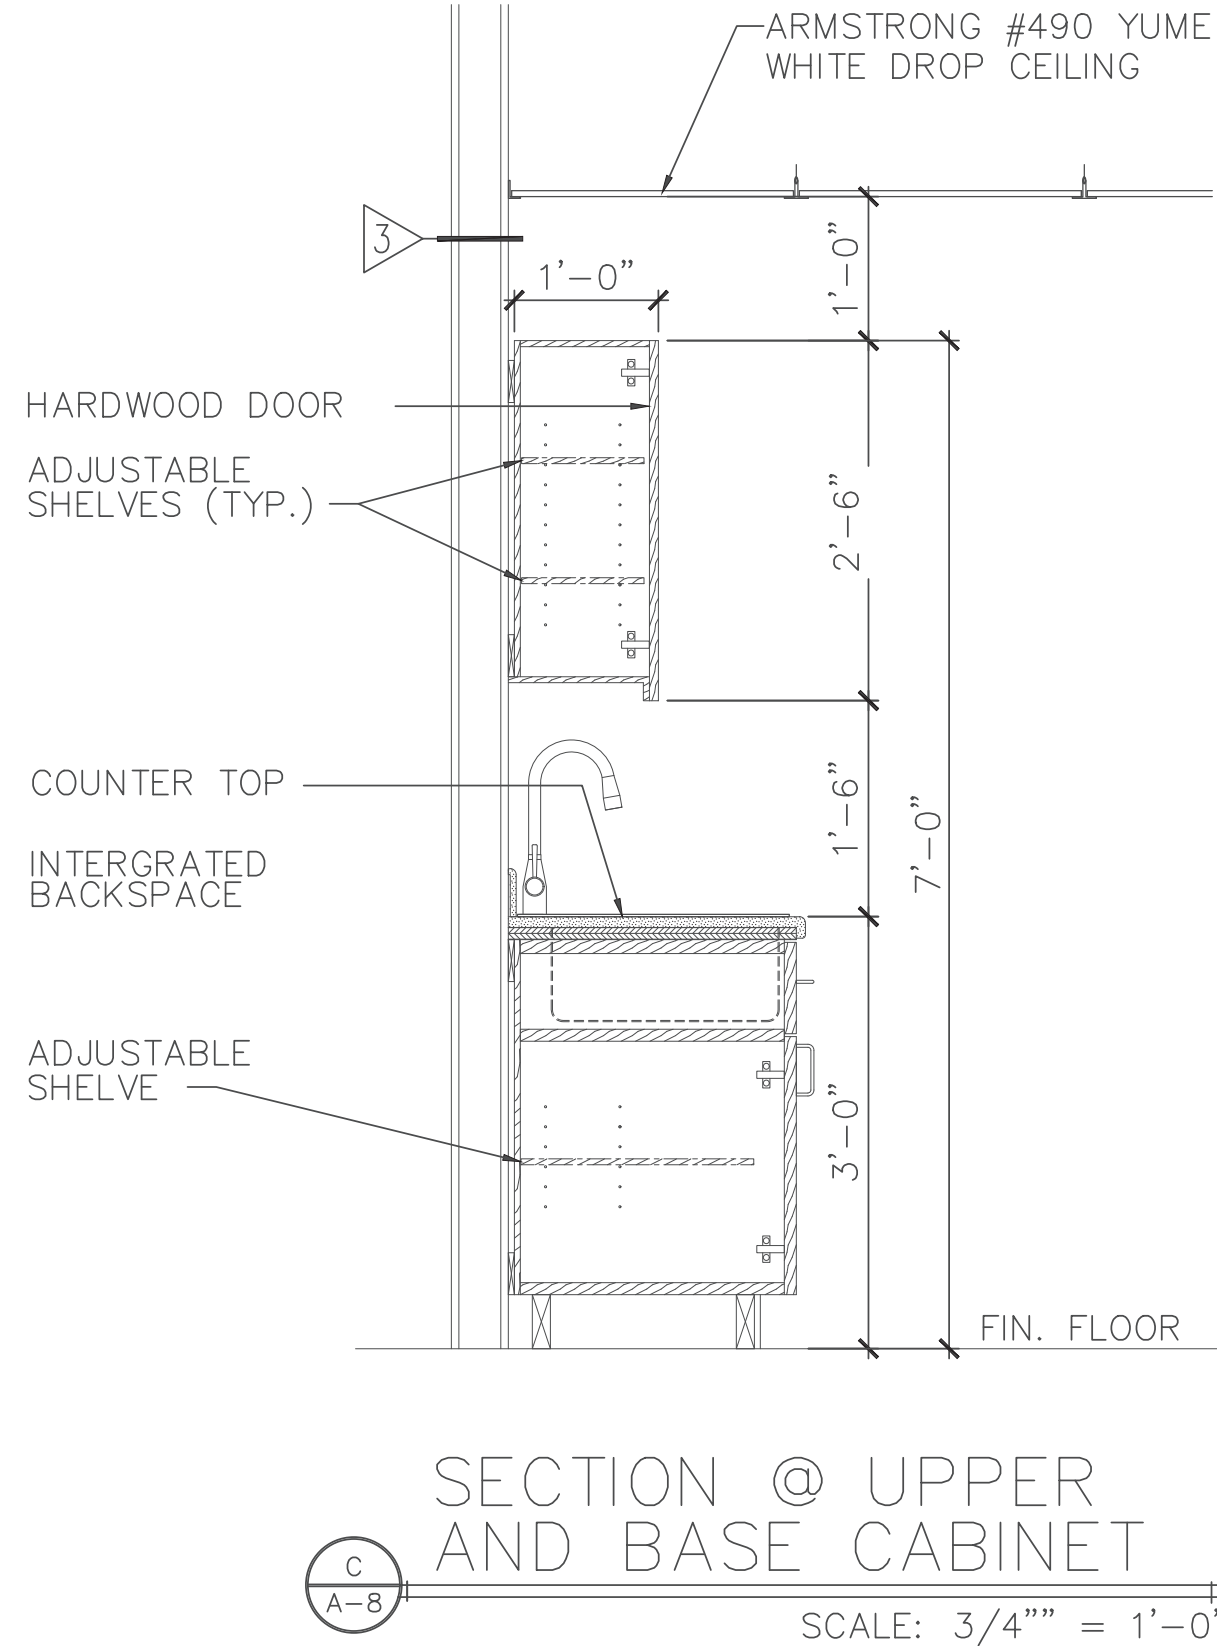
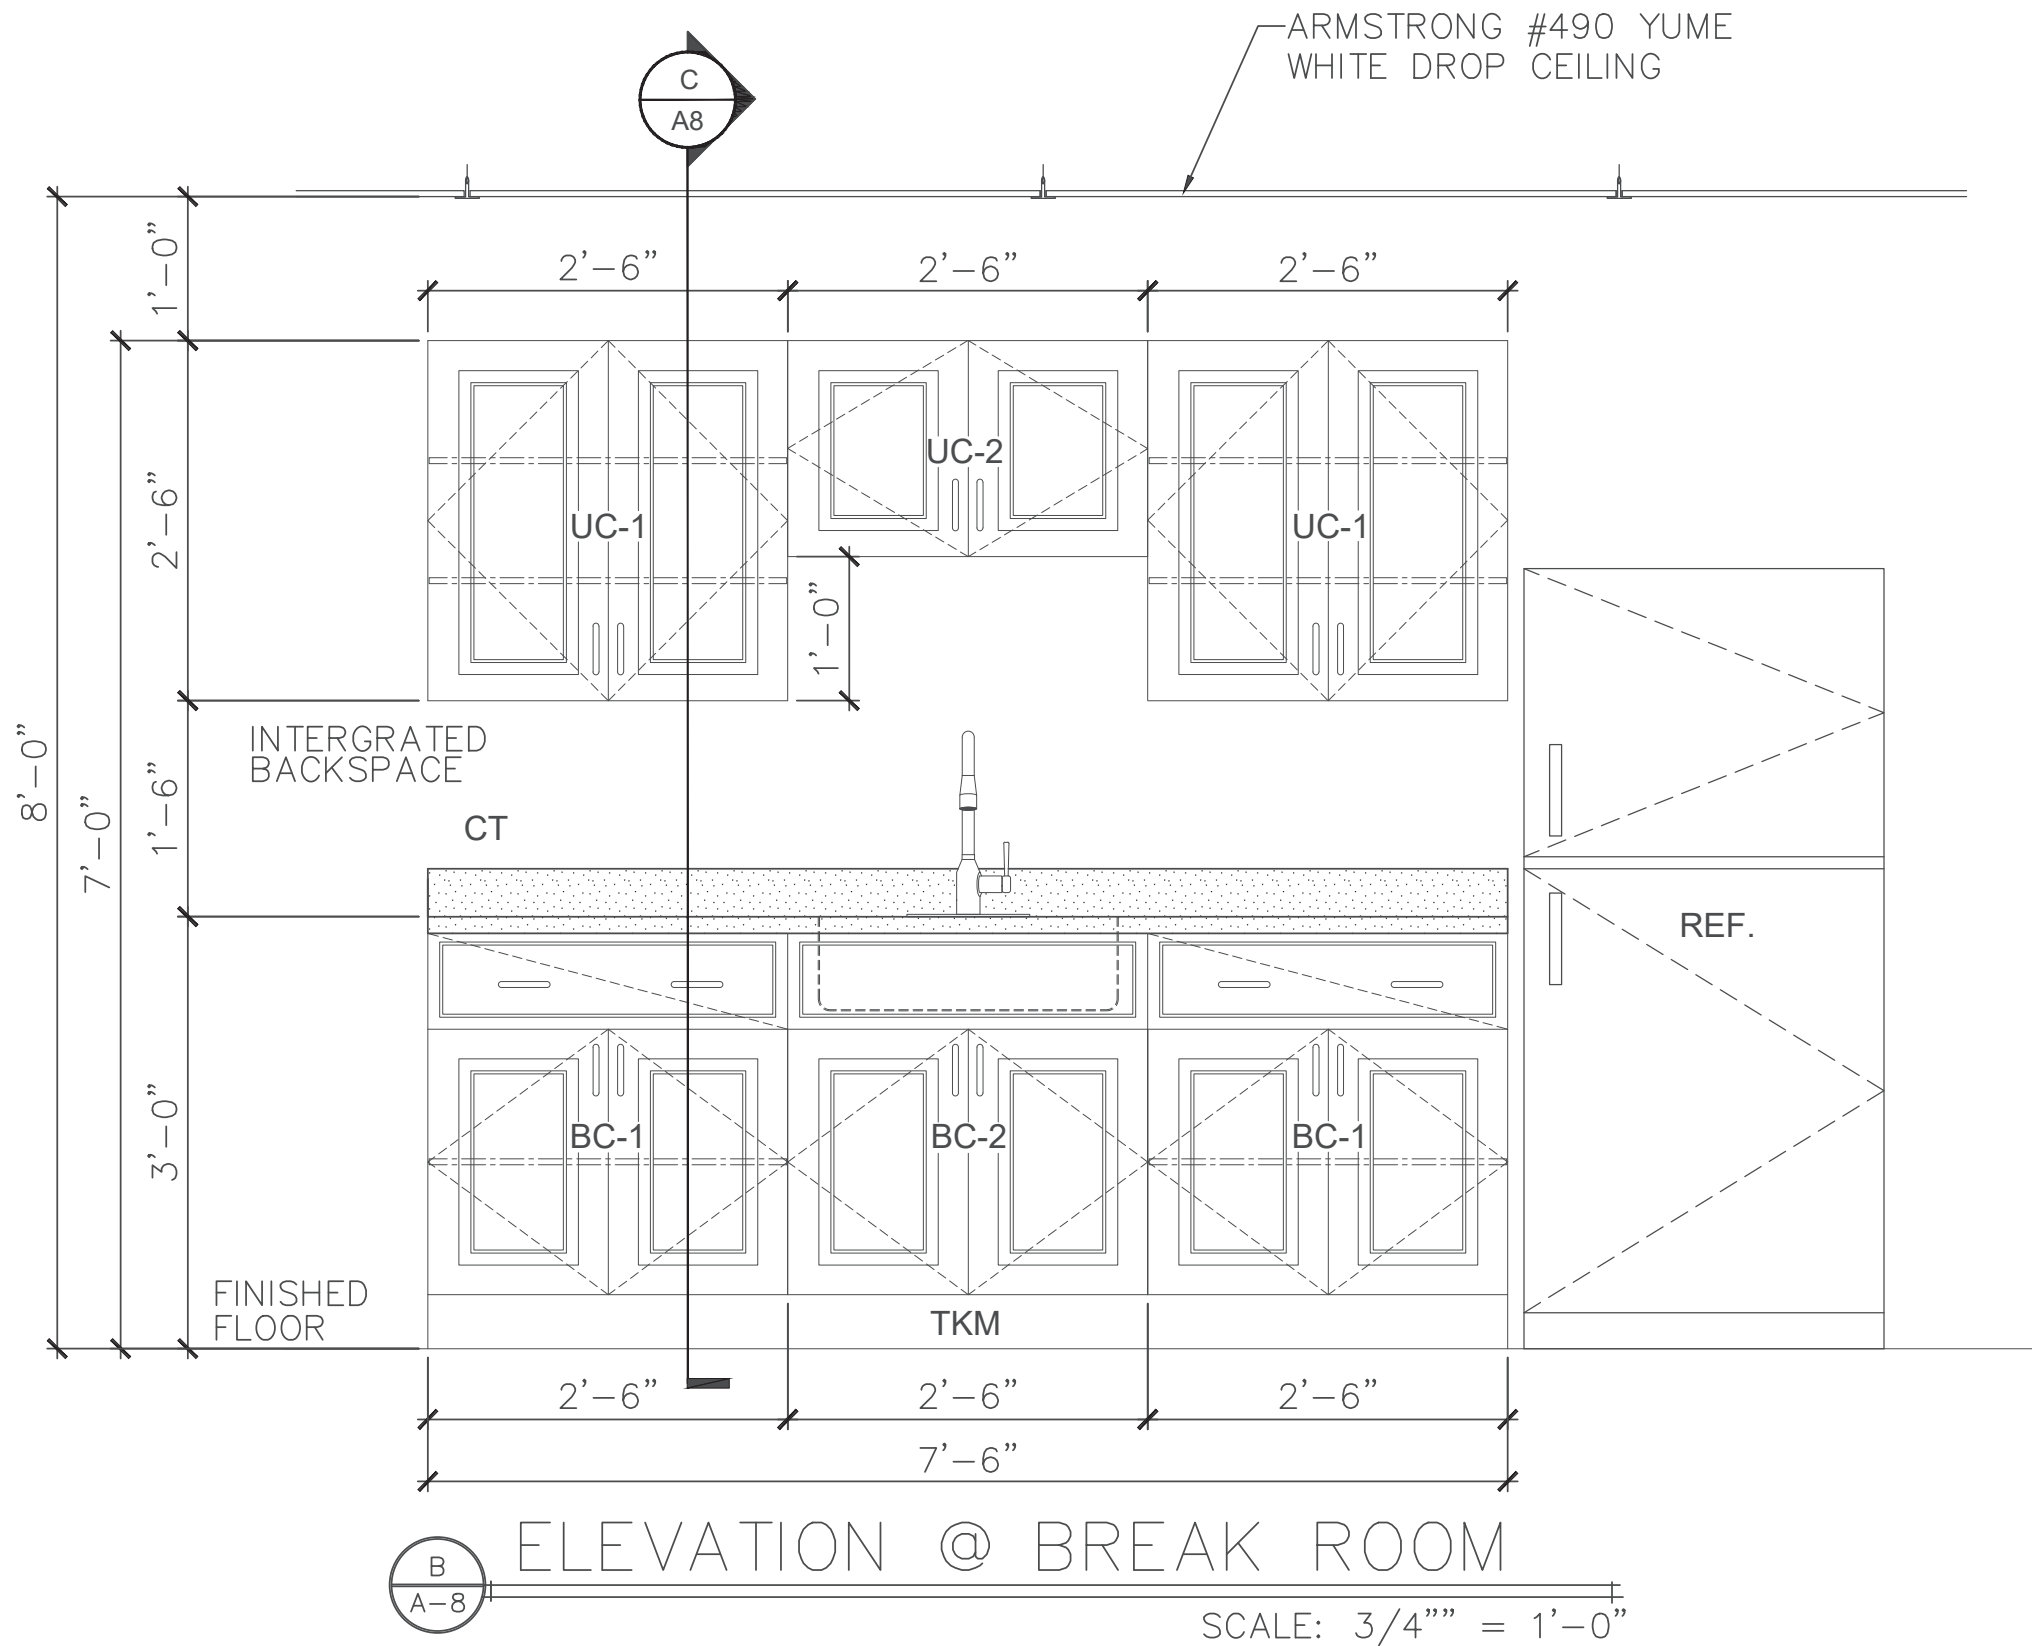


I:_2022\2251009 SHT ENGINEERING PLANNING\TASK 20 NEW EQUIPMENT BUILDING\SPEC PACKAGE SHT EQUIPMENT BUILDING\SH1\CONTRACT BID DOCUMENTS\SH1 MUNICIPAL BLDG - 2251009-20.DWG

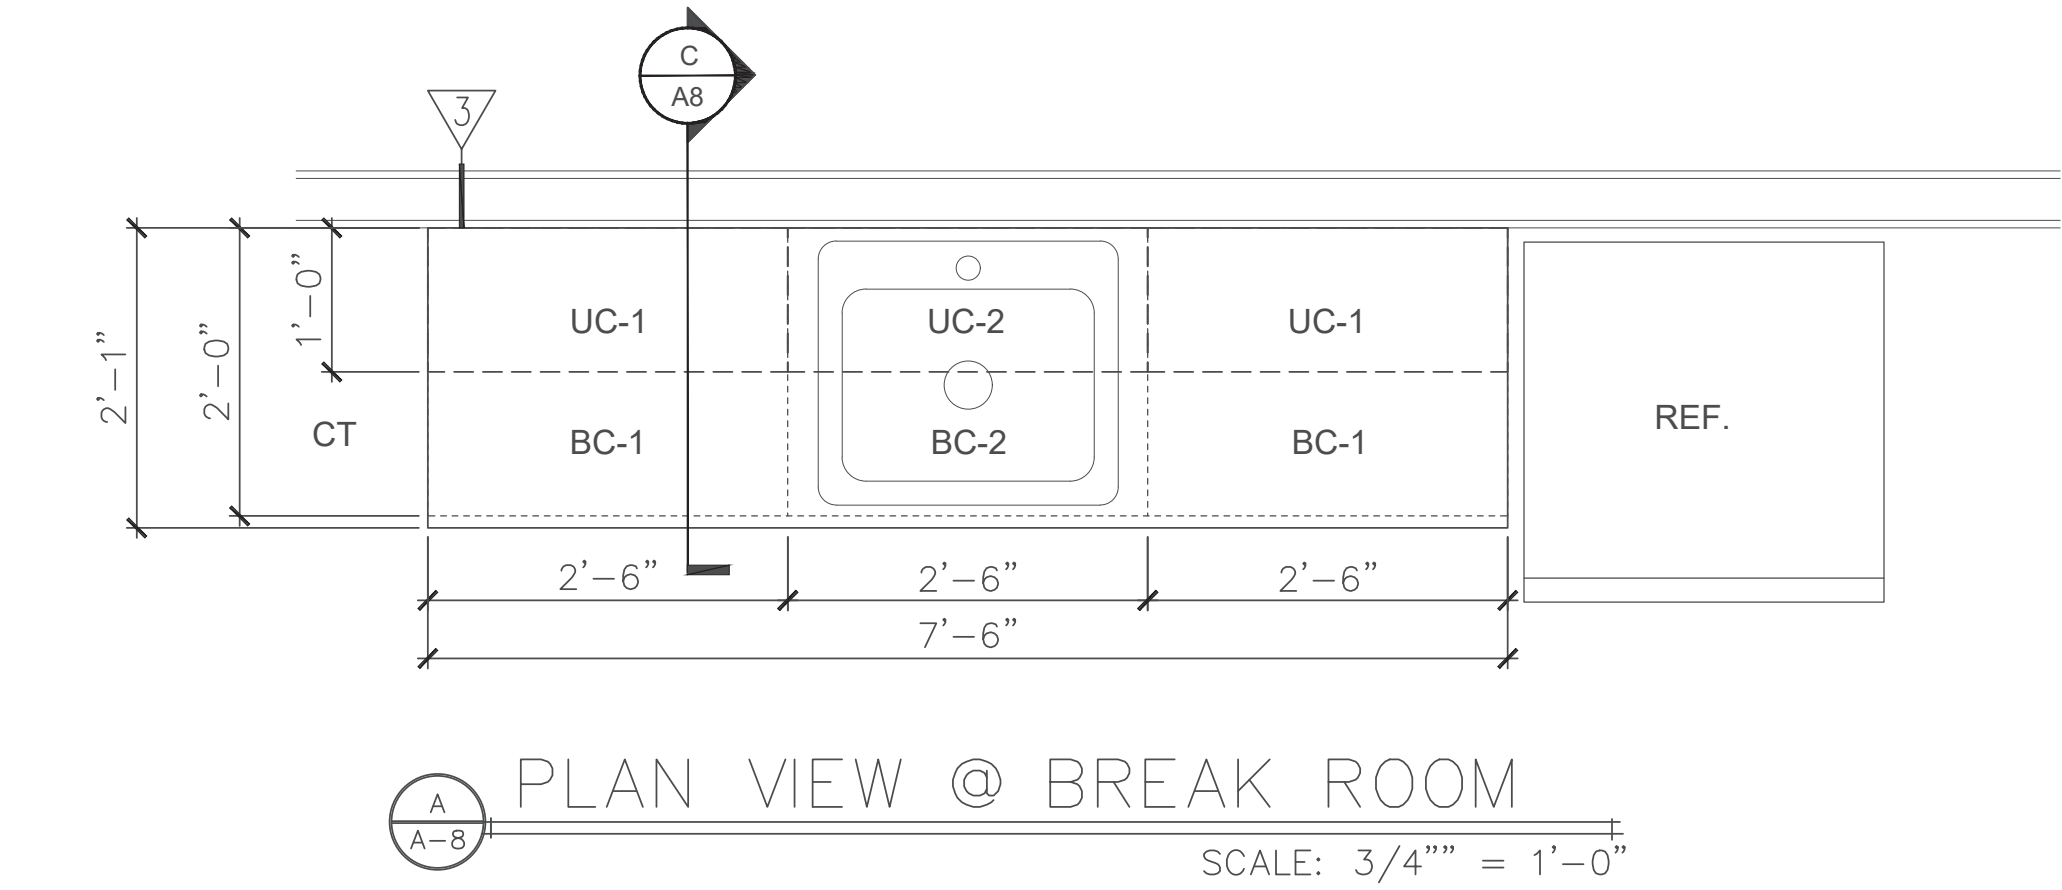

MARK	WALL TYPE DESCRIPTION
1	CORRUGATED METAL PANEL ON ONE SIDE WITH WITH .8" GIRTS, NON-RATED INTERIOR BEARING PARTITIONS & 1/2" PLYWOOD ON THE OTHER SIDE OF 2x8" WOOD STUDS AT 16" O.C.
2	CORRUGATED METAL PANEL ON ONE SIDE WITH WITH .6" GIRTS, NON-RATED INTERIOR NON-BEARING PARTITIONS & 1/2" PLYWOOD ON THE OTHER SIDE OF 2x6" WOOD STUDS AT 16" O.C.
3	NON-RATED INTERIOR BEARING PARTITIONS - 2x8" WOOD STUDS @ 16" O.C. WITH 1 LAYER OF 1/2" GWB. ON BOTH SIDES. (SUBSTITUTE 1/2" PLYWOOD FOR GWB. IN ROOM #5)
4	NON-RATED INTERIOR NON-BEARING PARTITIONS - 2x6" WOOD STUDS @ 16" O.C. WITH 1 LAYER OF 1/2" GWB. ON BOTH SIDES. (SUBSTITUTE 1/2" PLYWOOD FOR GWB. IN ROOM #5)
5	NON-RATED INTERIOR BEARING PARTITIONS - 2x6" WOOD STUDS @ 16" O.C. WITH 1 LAYER OF 1/2" GWB. ON BOTH SIDES.
6	3-HOUR FIRE RATED NON-BEARING WALL - 6" STEEL STUDS, 2 1/2" FIBERGLASS INSULATION, AND 3 LAYERS OF 1/2" TYPE ULIX GWB. ON BOTH SIDES.

SYMBOL LEGEND

8	DOOR NUMBER
6	WINDOW TYPE
3	WALL TYPE
A or 1	STRUCTURAL GRID CALLOUTS
1 A-4	EXTERIOR WALL SECTION
1 A-5	BUILDING CROSS SECTION
DIMENSIONS ARE STUD TO STUD	

CABINET SCHEDULE										
ITEM DESIGNATION	QUANTITY	CABINET TYPE		DOOR STYLE & FINISHES	#DRWS	SHELVES	DIMENSIONS			NOTES
		UPPER CABINET	LOWER CABINET				LENGTH	DEPTH	HEIGHT	
BC-1	2		BASE	HAMPTON (RFT)	1	2	30"	24"	34-1/2"	HAMPTON BAY KB30-SJM
BC-2	1		SINK BASE	HAMPTON (RFT)	—	—	30"	24"	34-1/2"	HAMPTON BAY KSB30-SJM
UC-1	2	HIGH WALL		HAMPTON (RFT)	—	3	30"	12"	18"	HAMPTON BAY KW3030-SJM
UC-2	1	HIGH WALL BRIDGE		HAMPTON (RFT)	—	—	30"	12"	18"	HAMPTON BAY KW3018-SJM
TKM	1	TOE KICK MOLDING			—	—	—	—	4"	HAMPTON BAY KATKX-JM
CT	1	COUNTERTOP			—	—	78"	24"	—	HAMPTON BAY 011312010895008 WILSONART STRAIGHT LAMINATE COUNTERTOP IN TEXTURED PRALINE ANTICO WITH WATERFALL EDGE & INTERGRATED BACKSPLASH


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PENNSYLVANIA ONE CALL SYSTEM, INC.
1-800-242-1776
PENNSYLVANIA LAW REQUIRES NOT LESS THAN THREE NOR MORE THAN TEN WORKING DAYS NOTICE BEFORE EXCAVATION
REFER TO PENNSYLVANIA ONE CALL SYSTEM, INC. UTILITY LOCATIONS SHOWN HEREON ARE APPROXIMATE.

Engineer's Stamp:

I certify that to the best of my knowledge and belief this plan is true and correct and the Owner may rely upon the accuracy thereof.



Gregory Scott LeBO, P.E. # 49870-E

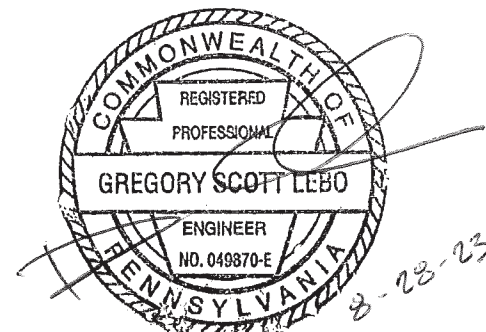REVISION NOTES	DATE
ADDENDUM #3	9/14/23
NO.	1

BREHM-LEBO ENGINEERING, INC.
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PH: (717) 243-4114
FAX: (717) 243-3301

KITCHEN CABINETS & SCHEDULES
CONSTRUCTION DRAWINGS
FOR
TOWNSHIP EQUIPMENT BUILDING
CUMBERLAND COUNTY, PA
SOUTHAMPTON TWP.

Drawn By: DNF
Designed By: BSC
Checked By: GSL
File: 2022-SH-009
Date: 8/21/2023
Scale: AS NOTED
Drawing No.

A-8

NOT FOR CONSTRUCTION - ISSUED FOR BID AND PERMIT 08-21-23