



1 CLERESTORY FLOOR PLAN - HVAC
1/8" = 1'-0"


SPECIFIC NOTES - HVAC NEW	
M2	60" X 20" SA/RA DUCT UP TO RTU 1. TRANSITION AND CONNECT TO FULL SIZE OF UNIT CONNECTION.
M4	60" X 20" SA/RA DUCT UP TO RTU 2. TRANSITION AND CONNECT TO FULL SIZE OF UNIT CONNECTION.
M6	60" X 20" SA/RA DUCT UP TO RTU 3. TRANSITION AND CONNECT TO FULL SIZE OF UNIT CONNECTION.
M9	PROVIDE SHEET METAL SHOPDRAWINGS FOR WORK IN THIS AREA
M10	RELOCATION OF EXISTING F-13 FAN IN FAN ROOM 3 IS PART OF BASE BID 1 ONLY.
M11	20" X 12" SA DUCT UP TO RTU 6. TRANSITION AND CONNECT TO FULL SIZE OF UNIT CONNECTION.
M12	20" X 12" RA DUCT UP TO RTU 6. TRANSITION AND CONNECT TO FULL SIZE OF UNIT CONNECTION.
M15	CONNECT 48"x30" RA DUCT TO EXISTING GRATE.
M16	FIVE RA DUCT PLENUM OPENINGS WITH FIRE DAMPERS. FIELD VERIFY QUANTITY AND SIZES FOR RA DUCT CONNECTION. COMBINE TO FULL SIZE RA DUCT IN MECHANICAL ROOM.
M17	CONNECT NEW OUTSIDE AIR DUCT TO EXISTING LOUVER UNDER BASE BID 3 ONLY.
M22	24X24 RETURN AIR GRILLE ON FACE OF WALL.
M25	NEW DUCTWORK FROM RTU-8 IN FAN ROOM 3 IS PART OF BASE BID 1 AND BASE BID 2 ONLY.
M26	CONNECT NEW OUTSIDE AIR DUCT TO EXISTING LOUVER UNDER BASE BID 2 ONLY.
M31	PROVIDE AIRFLOW SENSOR DOWNSTREAM OF F-13 TIED TO BMS TO ALERT STAFF WHEN SYSTEM IS NOT IN OPERATION.

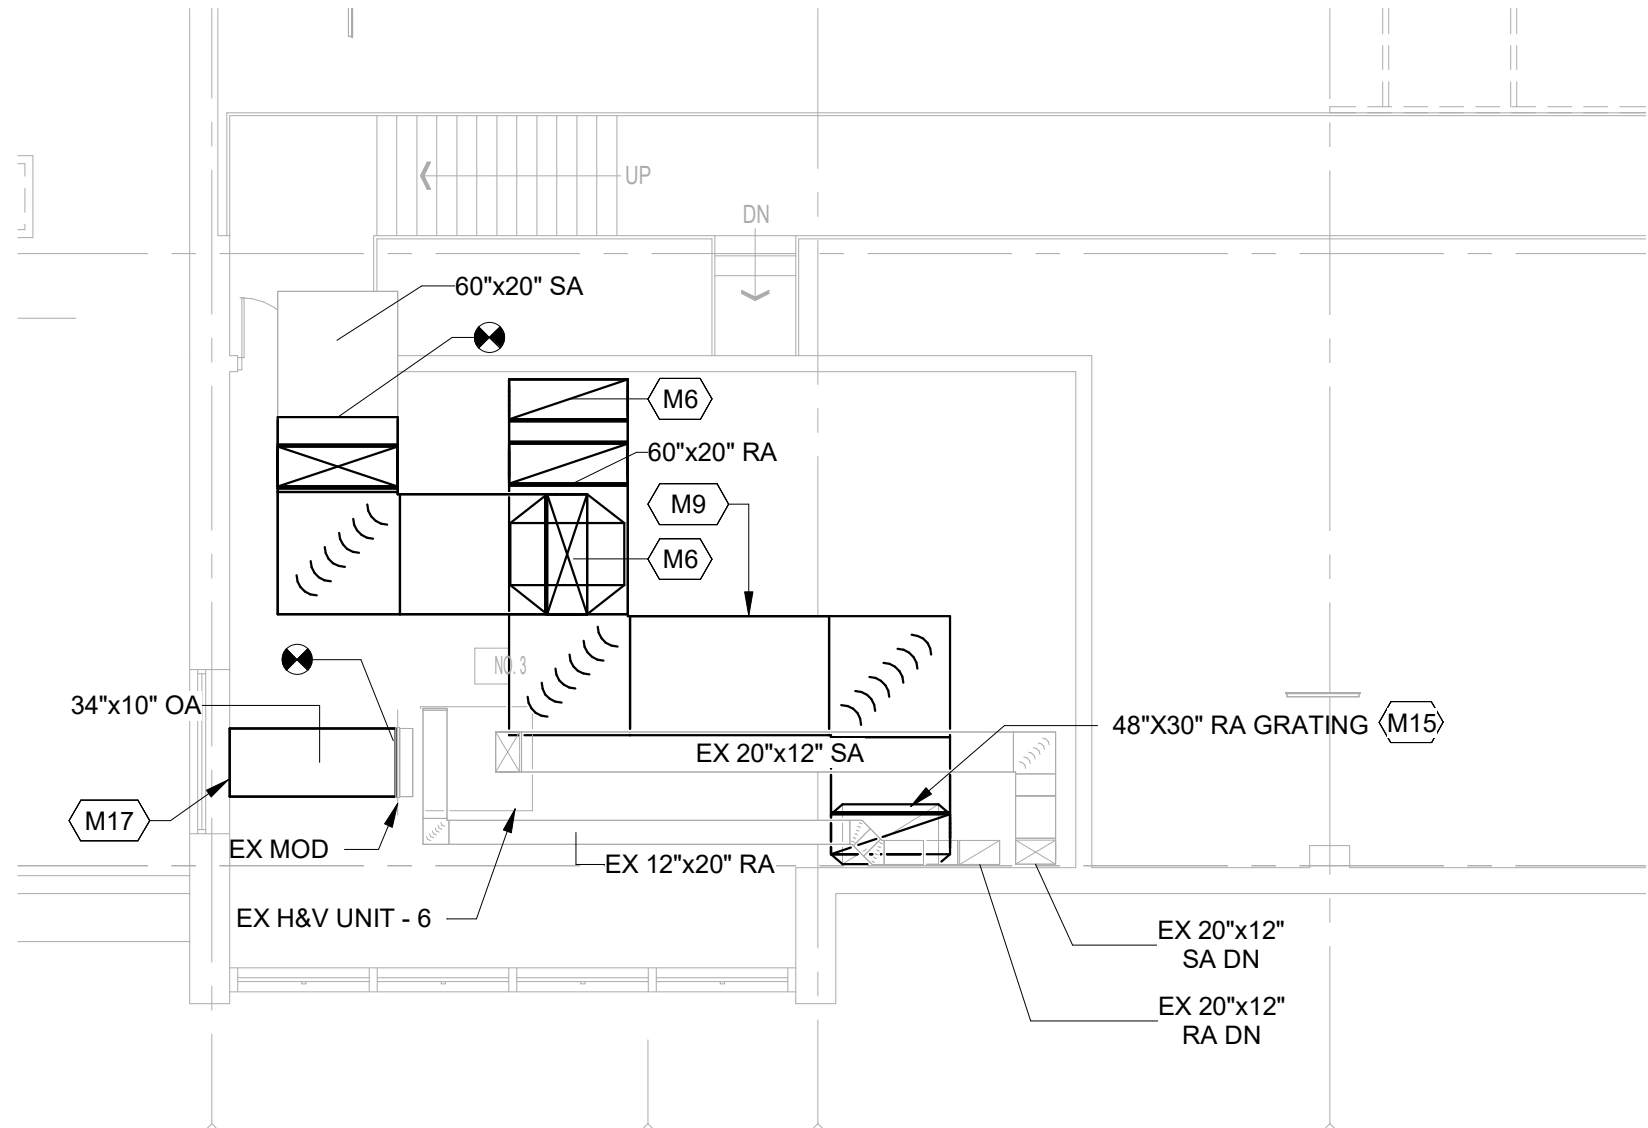

2 FAN RM 3 PART PLAN - BASE BID 3
1/8" = 1'-0"

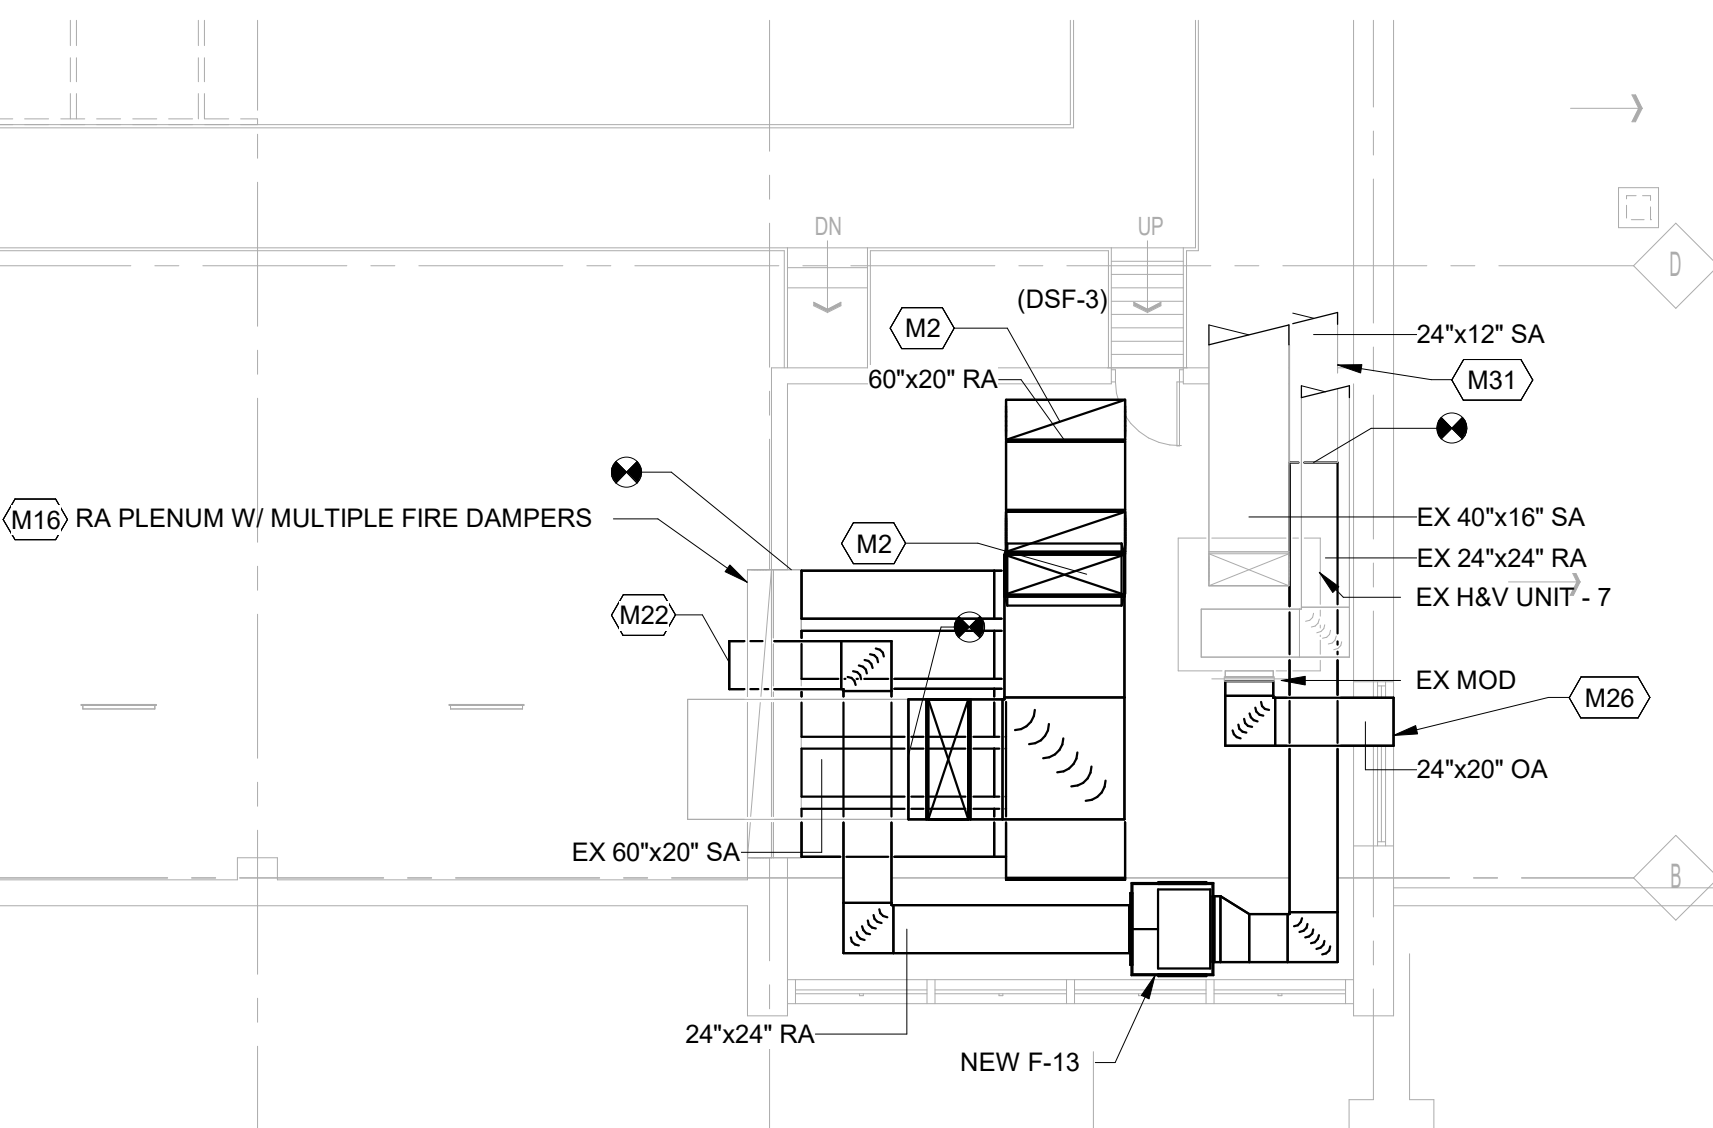

3 FAN RM 1 PART PLAN - BASE BID 2
1/8" = 1'-0"

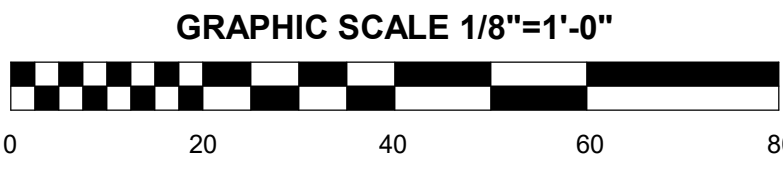

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SEAL

NO.	DESCRIPTION	DATE
REVISIONS		

MILLERSVILLE UNIVERSITY
MI-12/13 PUCILLO HVAC RENOVATION

125 PUCILLO DRIVE MILLERSVILLE, PA. 17551

SHEET TITLE
CLERESTORY
FLOOR PLAN -
HVAC

ISSUE DATE: 11.17.2023
DRAWN DESIGNED CHECKED
SS JE JB
SCALE SHEET NO.
AS NOTED H-103
PROJECT NO.
24000543.001A