

- KEY NOTES**
- E1 THE .4 ELECTRICAL CONTRACTOR SHALL REMOVE, RELOCATE, AND TEMPORARILY SUPPORT THE CABLE TV CABLES AND EQUIPMENT.
 - E2 THE .4 ELECTRICAL CONTRACTOR SHALL REMOVE AND DISCARD EQUIPMENT.
 - E3 COMCAST SHALL REMOVE, RELOCATE, AND TEMPORARILY SUPPORT CABLE TV CABLE AND EQUIPMENT. THE .4 ELECTRICAL CONTRACTOR SHALL COORDINATE WITH THE CLIENT AGENCY AND CAPITOL MEDIA SERVICES (CMS).
 - E4 THE .4 ELECTRICAL CONTRACTOR SHALL DISCONNECT AND SALVAGE EXISTING TELEPHONE, THEN REINSTALL AFTER THE NEW CMU WALL IS CONSTRUCTED.
 - E5 REFER TO NOTES EC23 AND E18 ON DRAWING E212 FOR ADDITIONAL INFORMATION.
 - E6 THE .1 GENERAL CONTRACTOR SHALL REMOVE PLYWOOD BACKBOARD AND REINSTALL ON NEW CMU WALL ONCE IT IS CONSTRUCTED.

EXISTING I.T. BACKBOARD & EQUIPMENT 04

POWER PANEL		208/120 V AC	BUS 100 A COPPER	<input checked="" type="checkbox"/> EXISTING PANEL	<input type="checkbox"/> NEW PANEL		
XC	BUILDING: PA CAPITOL EAST WING FLOOR: CONCOURSE ROOM: ELECTRICAL M43EA	3 PHASE 4 WIRE + GROUND	<input type="checkbox"/> MAIN LUGS ONLY <input checked="" type="checkbox"/> SURFACE MOUNTED <input type="checkbox"/> BOLTED BRANCH C.B.	<input type="checkbox"/> A MAIN C.B. <input type="checkbox"/> FLUSH MOUNTED <input type="checkbox"/> PLUG-IN BRANCH C.B.			
CKT No.	CIRCUIT DESCRIPTION	MINIMUM WIRE SIZE (*)	CIRCUIT BREAKER	CIRCUIT BREAKER	MINIMUM WIRE SIZE (*)	CIRCUIT DESCRIPTION	CKT No.
1	HEAT AT RECEPTION DESK	EXISTING	20 1	15 1	EXISTING	RECEPTACLES	2
3	METAL DETECTOR	EXISTING	20 1	15 1	EXISTING	RECEPTACLES	4
5	RECEPTACLES IN ROOM 40	EXISTING	20 1	2 2	2#12 + #12G	AC INDOOR UNIT IU-1	6
7	UNKNOWN	EXISTING	20 1	20 1	EXISTING	CAPITOL DISPLAY POWER POKE-THRU	8
9	SOL DESK	EXISTING	20 1	20 1	EXISTING	EXHAUST FAN No. 10	10
11	SOL DESK	EXISTING	20 1	20 1	EXISTING	EXHAUST FAN No. 9	12
13	RECEPTACLES IN GIFT SHOP	EXISTING	20 1	15 1	EXISTING	RECEPTACLES	14
15	RECEPTACLES IN GIFT SHOP	EXISTING	20 1	2 2	2#12 + #12G	AC INDOOR UNIT IU-2	16
17	ELEVATOR CAB LIGHTS, 01 REVISED NOTATION	EXISTING	20 1	20 1	EXISTING	CATHODE LIGHTING NEAR GIFT SHOP AND DISPLAY CASE LIGHTS	18
19	RECEPTACLES IN STORAGE P1-1S RECEPTACLES ELEVATOR MACHINE P1-EM	2#10 + #12G	20 1	100 1	EXISTING	RECEPTACLES	20
21						MCB	22
23	CONDENSER C-1	2#4 + #6G	50 2	3 3	EXISTING	CONDENSER	24

REMARKS

- CIRCUIT INFO IS FROM EXISTING PANEL DIRECTORY. CONTRACTOR SHALL VERIFY CIRCUITS BEFORE COMMENCING ANY WORK.
- COMBINE EXISTING CIRCUIT 16 (CATHODE LIGHTING NEAR GIFT SHOP) WITH CIRCUIT 18 (DISPLAY CASE LIGHTING). PROVIDE AMP READING ON CIRCUITS BEFORE PROCEEDING.
- COMBINE EXISTING CIRCUITS 15 AND 17 (GIFT SHOP RECEPTACLES). PROVIDE INVESTIGATION OF QUANTITY OF RECEPTACLES CONNECTED TO CIRCUITS 15 AND 17 AND AN AMP READING BEFORE PROCEEDING TO COMBINE CIRCUITS.

ADDED REMARK 3, 01

ELECTRICAL PANEL SCHEDULE 03

TYPE	GENERAL DESCRIPTION	MANUFACTURER MODEL	PRIMARY APPLICATION	MOUNTING	VOLTS	LUMENS / K CRI / WATTS	COMMENTS
A	LED STRIP	LITHONIA CSS-L48-4000LM-AL03-MVOLT-35K-80CRI	ELEVATOR MACHINE ROOM	CHAIN HUNG	277	4000 LM / 80 35.8 WATTS	SWITCHABLE LUMENS (3000 LM / 4000 LM / 5000 LM)
B	LOW PROFILE LED LINKABLE LINEAR	G & G GPX4-SO-40K-GC-SE-277V	ELEVATOR PIT	WALL	277	600 LM PER FT 36 WATTS	DIRECT AC DRIVERLESS
C	LED PANEL	LITHONIA CPX-2x4-AL07-80CRI-SWW7-SWL-ZT-277V	CAFETERIA	CEILING RECESSED	277	4000 LM 24.9 WATTS	SWITCHABLE LUMENS (2500 LM / 3200 LM / 4000 LM) SWITCHABLE COLOR TEMPERATURE (35K / 40K / 50 K)
D	LINEAR ACCENT LED	TEMPO CLIP3-FL-0-6-RGB-LG-4	ROTUNDA LIGHT COVE	COVE	277	25 WATTS	PROVIDE DIMMABLE POWER SUPPLY (MODEL PWR-UNV-EM-96X-DMX) PROVIDE SURGE SUPPRESSION DEVICE (MODEL SSD-227)
E	LED PANEL	CPX 2x4 4300LM-35K-UVOLT-MW	A/V ROOM	CEILING SURFACE	277	4300 LM 40 WATTS	PROVIDE SURFACE MOUNT KIT (2x4 SMKSH)

LIGHT FIXTURE SCHEDULE 02

GENERAL NOTES

- KEY NOTES BELOW REFER TO ELECTRICAL RENOVATION WORK AT ABOVE UPPER PARKING LEVEL (P1).
- KEY NOTE LOCATIONS FOR ELECTRICAL RENOVATION WORK ARE IN DETAIL 01/E212u FOR ABOVE UPPER PARKING LEVEL (P1).
- REFER TO DRAWING A212u FOR ARCHITECTURAL RENOVATION WORK FOR THIS AREA.
- COORDINATE ALL DEMOLITION WORK WITH THE .1 GENERAL CONTRACTOR.
- REFER TO DETAIL 03/E212u FOR LIGHT FIXTURE SCHEDULE.


.4 ELECTRICAL CONTRACT - LIGHTING & POWER

FOR THE DURATION OF THE CONSTRUCTION ACTIVITIES, THE .1 GENERAL CONTRACTOR SHALL PRESERVE AND PROTECT ALL EXISTING CONDITIONS TO REMAIN AND SHALL ENSURE THE BUILDING'S OCCUPANTS MAY SAFELY USE SPACES IN THE AREAS OF THE BUILDING NOT BEING RENOVATED.

- E1 POWER FROM EXISTING LIGHTING CIRCUIT.
- E2 NEW WALL-MOUNTED LIGHT FIXTURE. REFER TO TECHNICAL SPECIFICATIONS FOR MANUFACTURER, MODEL, ETC.
- E3 NEW POWER RECEPTACLE. CIRCUIT AS NOTED.

SCALE 3/8" = 1'-0"

KEY NOTES FOR ELECTRICAL RENOVATION WORK 01K

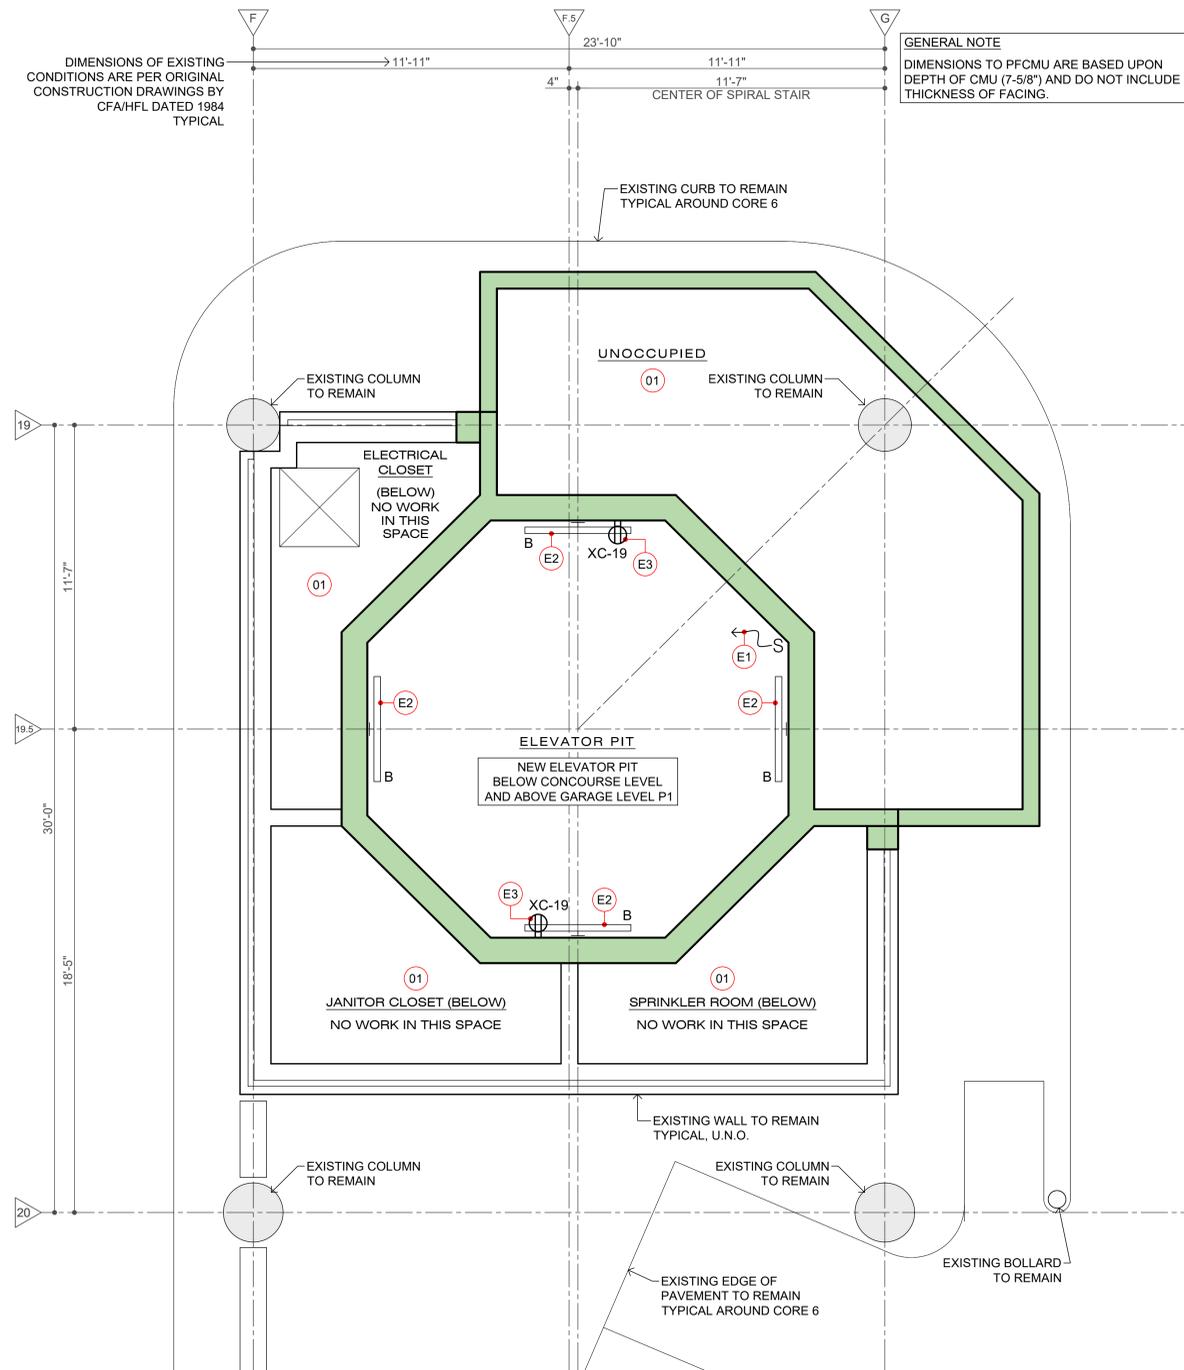

SCALE 3/8" = 1'-0"

CORE 6 - ABOVE UPPER PARKING LEVEL P1 - RENOVATION PLAN 01

SCALE & DIMENSIONS	BASE BIDS
BAR IS ONE (1) INCH LONG ON ORIGINAL DRAWING 0 1	ALL WORK SHOWN ON THIS DRAWING IS INCLUDED IN BASE BID 01, UNLESS NOTED OTHERWISE ON THIS DRAWING. REFER TO PROJECT MANUAL FOR FULL DESCRIPTION OF ALL BASE BIDS.
IF BAR IS NOT ONE (1) INCH LONG, ADJUST SCALE ACCORDINGLY. CONTRACTOR SHALL FIELD VERIFY ALL DIMENSIONS. VARIANCE FROM CONTRACT NOT PERMITTED WITHOUT BUREAU OF ENGINEERING AND ARCHITECTURE APPROVAL.	

ELECTRICAL DEVICE LEGEND	
	JUNCTION BOX
	DISCONNECT SWITCH
	120V DUPLEX POWER RECEPTACLE
	LIGHT FIXTURE/SCONCE
	EXISTING LIGHT FIXTURE
	LED LIGHT FIXTURE
	DOOR POSITION SWITCH
	MAGNETIC LOCK WITH DPS
	REQUEST TO EXIT DEVICE
	EMERGENCY CALL STATION
	CARD READER
	CCTV CAMERA
	SMOKE DETECTOR
	PUBLIC ADDRESS SYSTEM SPEAKER
	FIRE ALARM NOTIFICATION DEVICE
	FIRE ALARM MANUAL PULL STATION
	FIRE ALARM AUDIO/VISUAL DEVICE

AS-BUILT REVISIONS	
No.	DESCRIPTION
19	
17	
15	
13	
11	
09	
07	
05	
03	
01	ADDENDUM 02 02.12.2024

VITETTA PROJECT 4645.0000 © 2024 VITETTA
ALL DIMENSIONS MUST BE VERIFIED BY THE CONTRACTOR(S) AND THE ARCHITECT NOTIFIED OF ANY DISCREPANCIES BEFORE PROCEEDING WITH THE CONSTRUCTION TO THE SCALE THIS DRAWING.



VITETTA
ARCHITECTURE | ENGINEERING | PLANNING
HISTORIC PRESERVATION
645 NORTH 12TH STREET • SUITE 100
LEMOYNE • PENNSYLVANIA • 17043

COMMONWEALTH OF PENNSYLVANIA
DEPARTMENT OF GENERAL SERVICES
HARRISBURG, PENNSYLVANIA

DGS PROJECT NUMBER
C-0948-0101 PHASE 001
CAPITOL EAST WING
REPLACEMENT OF ESCALATORS WITH ELEVATOR
HVAC DIFFUSERS & CAFETERIA UPGRADES
HARRISBURG, DAUPHIN COUNTY, PENNSYLVANIA

**CORE 6
ABOVE UPPER PARKING LEVEL (P1)
DEMOLITION & RENOVATION**

DRAWN BY J. JOLIN DATE 01.04.2024 DRAWING NUMBER
E212u

CHECKED BY D. VOZDZAK SCALE 3/8" = 1'-0"

DRAWING IS INTENDED FOR COLOR PRINTING