



K
J
H
G
F
E
D
C
B
A

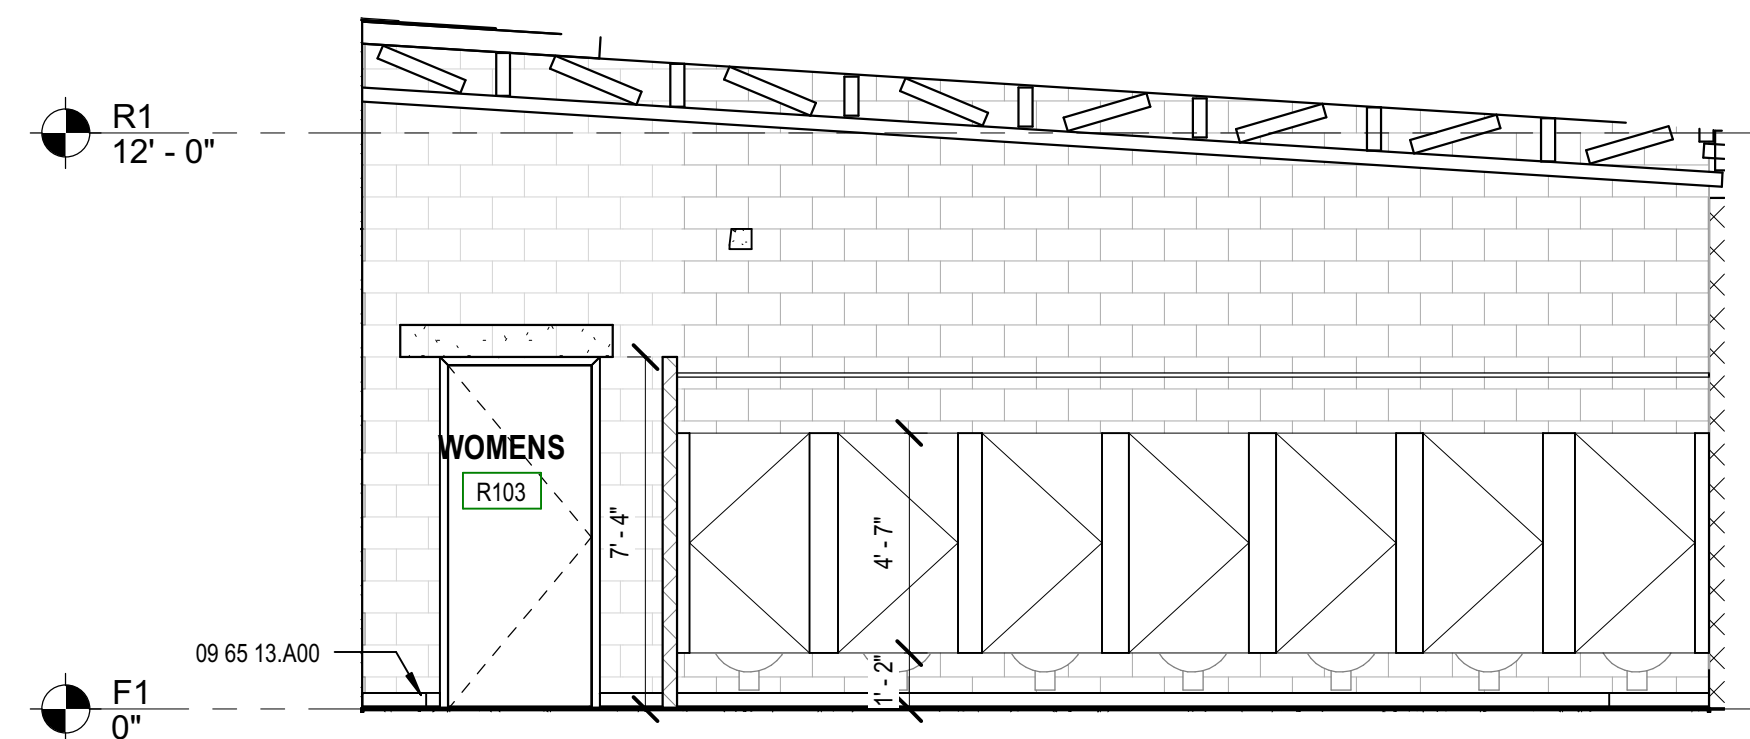


J1 INT. ELEVATION - R103 (WEST)
SCALE: 1/4" = 1'-0"




J4 INT. ELEVATION - R103 (EAST)
SCALE: 1/4" = 1'-0"

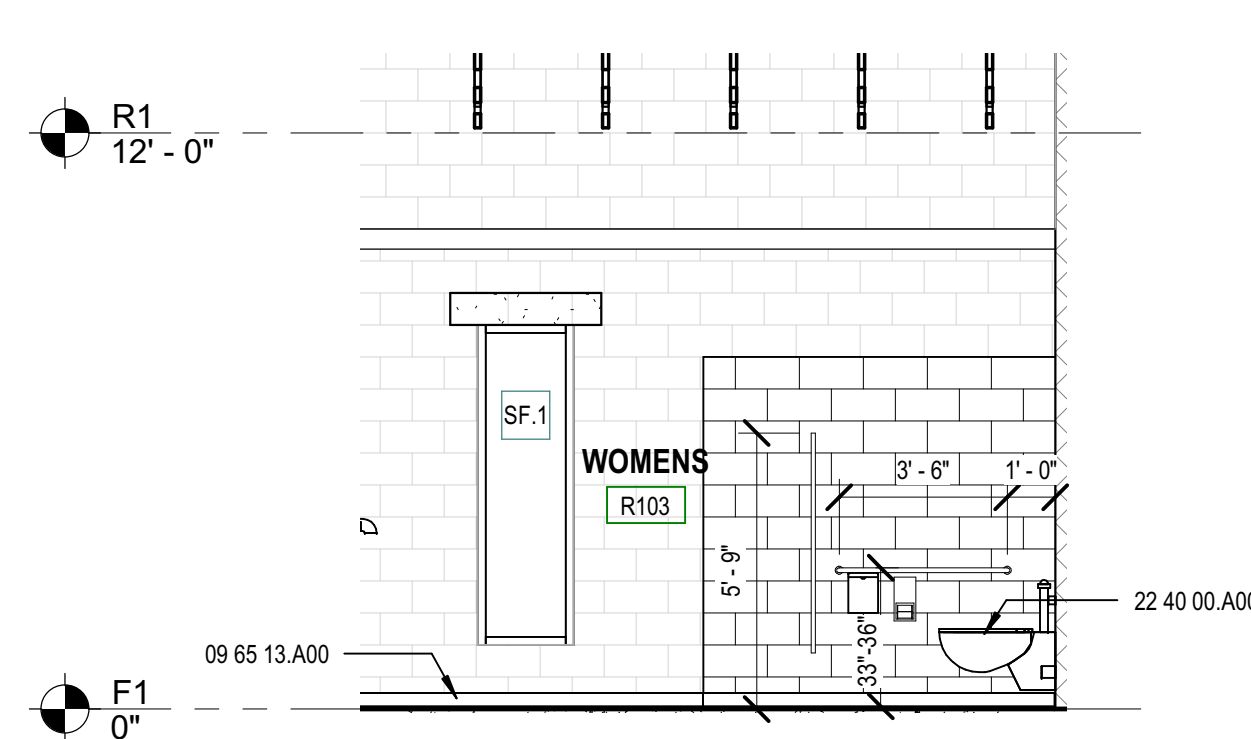


J8 INT. ELEVATION - R103 (SOUTH)
SCALE: 1/4" = 1'-0"

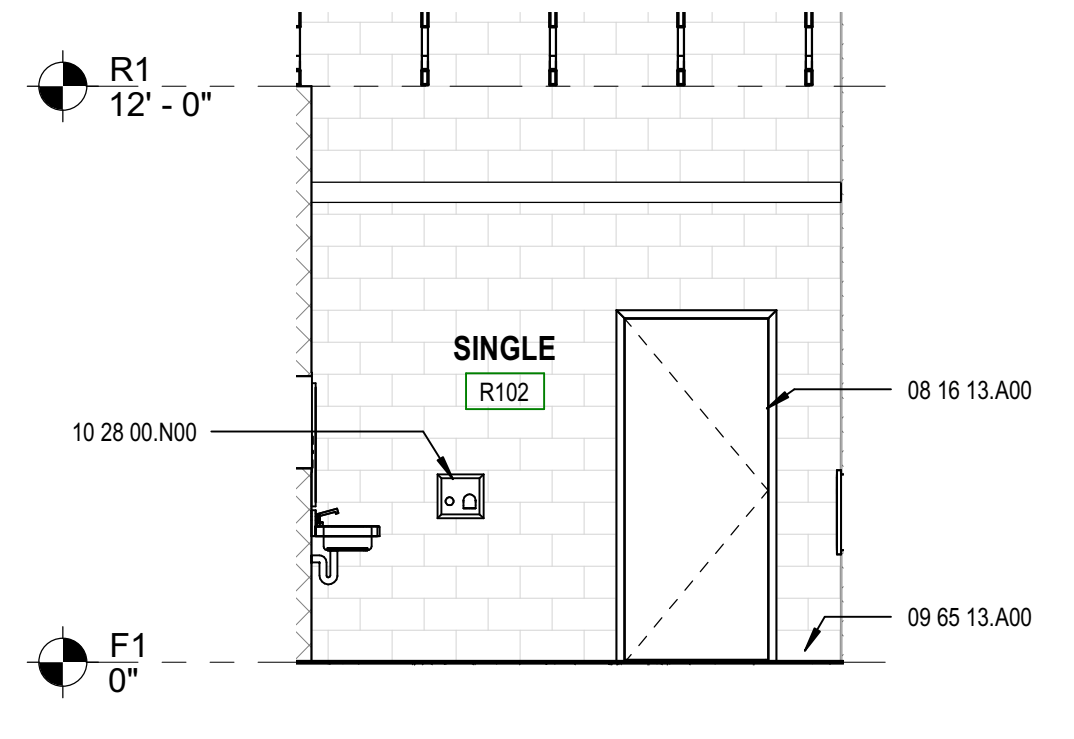


C3 INT. ELEVATION - R102 (SOUTH)
SCALE: 1/4" = 1'-0"

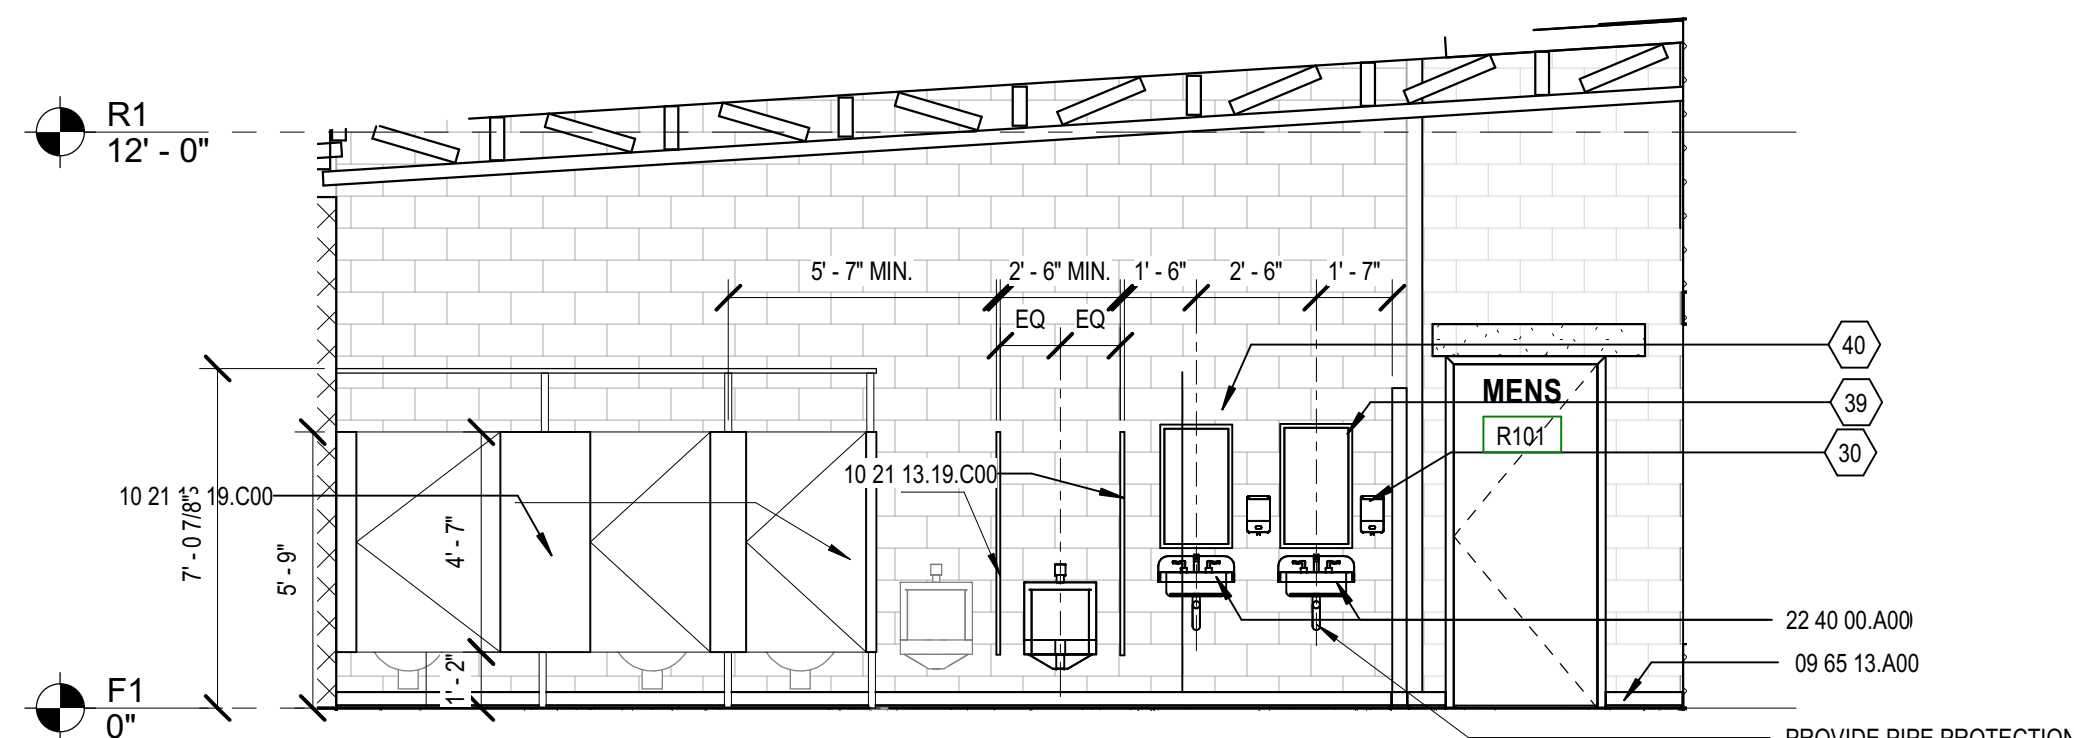


G1 INT. ELEVATION - R101 (EAST)
SCALE: 1/4" = 1'-0"

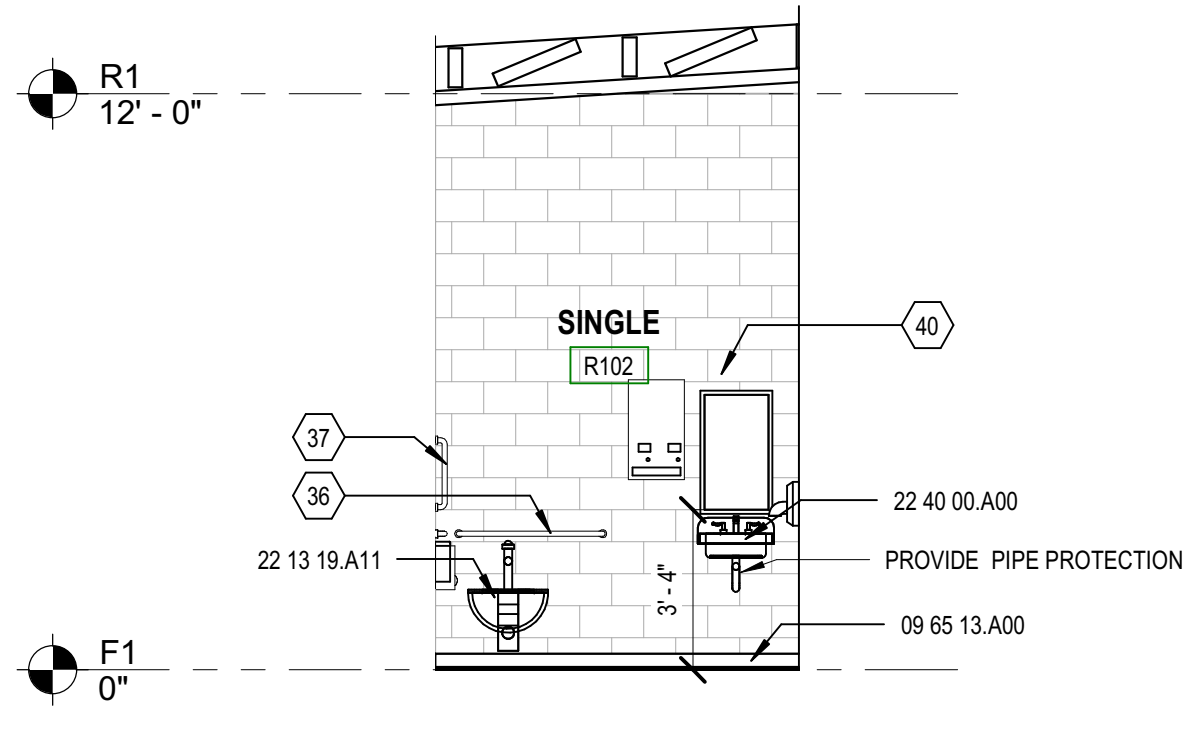

A1 INT. ELEVATION - R102 (EAST)
SCALE: 1/4" = 1'-0"

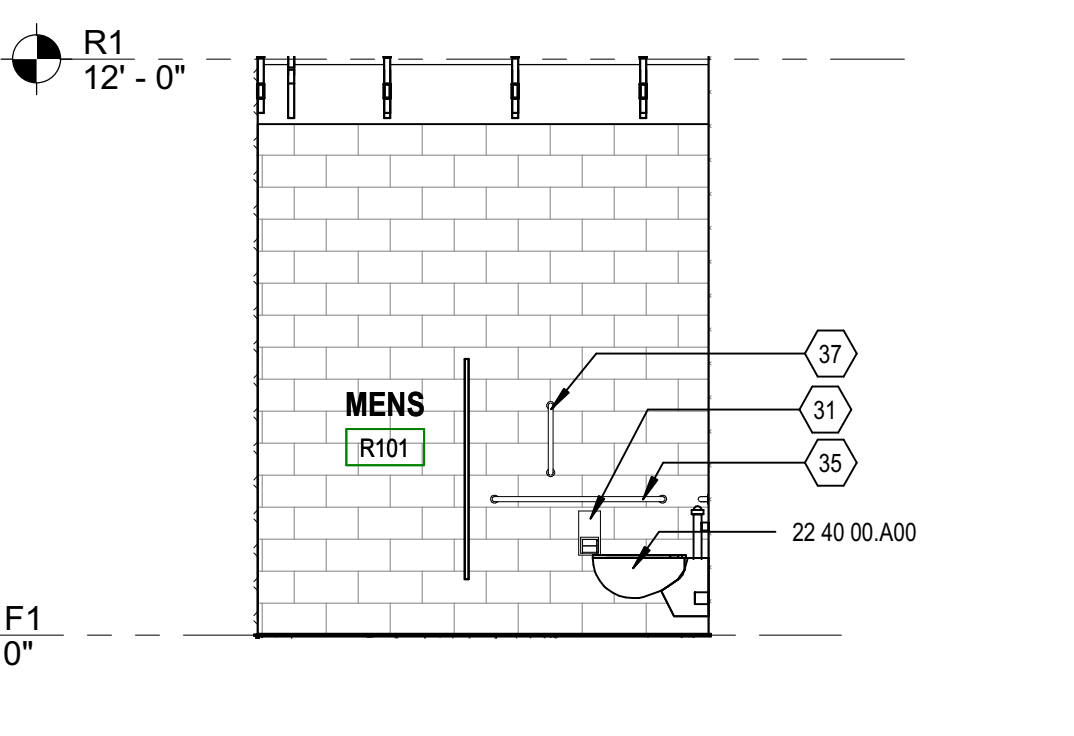

E1 INT. ELEVATION - R101 (NORTH)
SCALE: 1/4" = 1'-0"

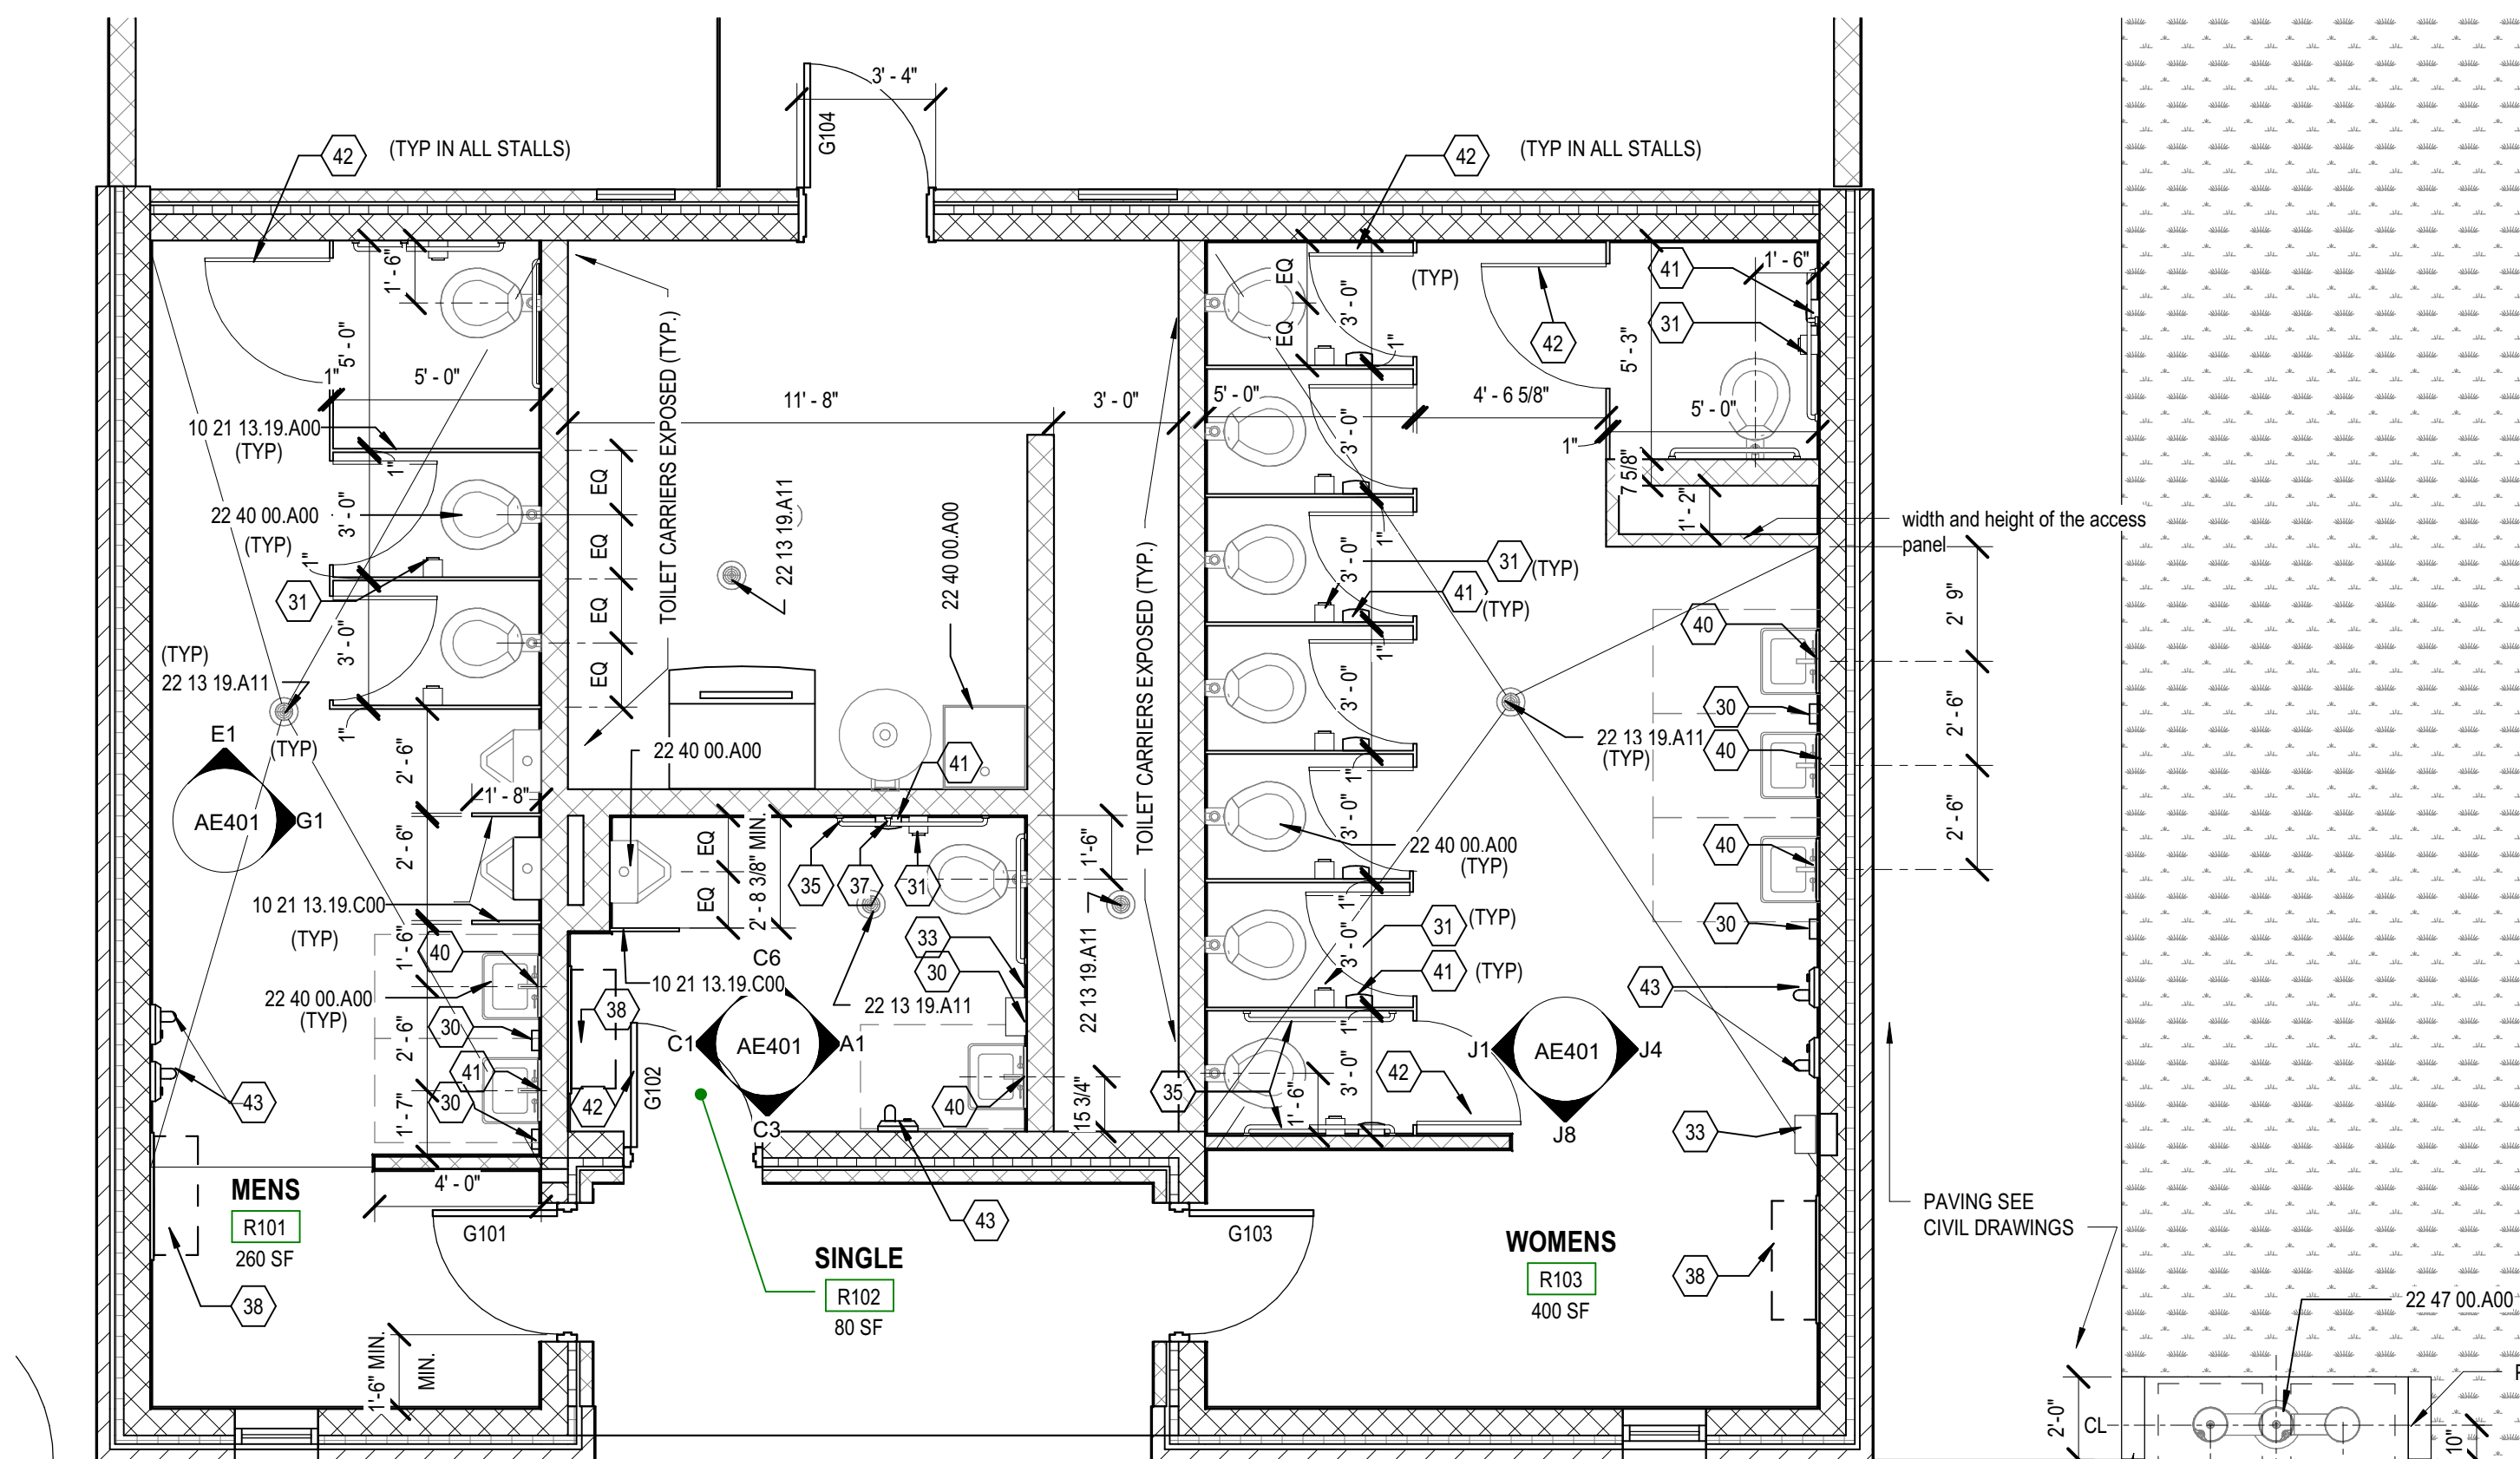

B1 ENLARGED PLAN
SCALE: 1/4" = 1'-0"

GENERAL SHEET NOTES

RESTROOM ACCESSORIES NOTES:
GRAB BARS:
GRAB BAR SHALL BE TYPE 304 STAINLESS STEEL WITH SATIN FINISH, SLIP-RESISTANT SURFACE. GRAB BAR SHALL HAVE 18-GAUGE (1/2MM) WALL THICKNESS AND 1-1/2" (38MM) OUTSIDE DIAMETER. CLEARANCE BETWEEN THE GRAB BAR AND WALL SHALL BE 1-1/2" (38MM). CONCEALED MOUNTING FLANGES SHALL BE 11-GAUGE (0.2MM) THICK STAINLESS STEEL PLATE, 2" X 3-1/2" (51 X 89MM), AND EQUIPPED WITH AT LEAST TWO SCREW HOLES FOR ATTACHMENT TO WALL. FLANGE COVERS SHALL BE 22 GAUGE (0.8MM), 3-1/4" (85MM) DIAMETER X 1/2" (13MM) DEEP, AND SHALL SNAP OVER MOUNTING FLANGE TO CONCEAL MOUNTING SCREWS AND/OR WINGNUT FASTENERS. ENDS OF GRAB BAR SHALL PASS THROUGH CONCEALED MOUNTING FLANGES AND BE HELIARC WELDED TO FORM ONE STRUCTURAL UNIT. GRAB BAR SHALL COMPLY WITH ACCESSIBLE DESIGN INCLUDING ADAAG IN THE U.S.A.) FOR STRUCTURAL STRENGTH.
USE MOUNTING KIT BOBRICK NO 252-30
INSTALL USING MANUFACTURER'S INSTRUCTIONS. GRAB BARS TO SUPPORT WEIGHT AS INDICATED BY CODES.

ACCESSIBLE MIRRORS:
TILT MIRROR ASSEMBLY SHALL CONSIST OF A MIRROR AND A SEPARATE WALL FRAME WITH BUILT-IN WALL HANGER. WALL FRAME FURNISHED WITH TUMBLER LOCK FOR SECURING MIRROR TO WALL FRAME. TILT MIRROR FRAME SHALL BE TYPE 304 STAINLESS STEEL WITH BEVELLED FRONT TO HOLD FRAME TIGHTLY AGAINST MIRROR. CORNERS SHALL BE WELDED, GROUND, AND POLISHED SMOOTH. WALL FRAME SHALL BE TYPE 304 STAINLESS STEEL DESIGNED WITH HORIZONTAL LOCKING BARS TO SECURE MIRROR TO WALL FRAME. ALL EXPOSED SURFACES SHALL HAVE SATIN FINISH WITH VERTICAL GRAIN. SELECT FLOAT GLASS MIRROR SHALL BE GUARANTEED FOR 15 YEARS AGAINST SILVER SPOILAGE. ALL EDGES SHALL BE PROTECTED BY PLASTIC FILLER STRIPS. BACK SHALL BE PROTECTED BY FULL-SIZE, SHOCK-ABSORBING, WATER-RESISTANT, NONABRASIVE, 1/8" (3MM) THICK POLYSTYRENE PADDING.

RESTROOM ACCESSORIES NOTES:

BABY CHANGING STATION:
BODY SHALL BE DURABLE, INJECTION-MOLDED POLYPROPYLENE. DESIGN OF UNIT SHALL BE SURFACE-MOUNTED. UNIT SHALL BE EQUIPPED WITH A PNEUMATIC CYLINDER FOR CONTROLLED OPENING AND CLOSING OF BED. BED SHALL BE SECURED TO METAL MOUNTING CHASSIS WITH A CONCEALED STEEL-ON-STEEL HINGE. NO HINGE STRUCTURE SHALL BE EXPOSED ON INTERIOR OR EXTERIOR SURFACES. UNIT SHALL HAVE MOUNTING HARDWARE INCLUDED. UNIT SHALL HAVE MICROBAND ANTIMICROBIAL EMBEDDED INTO PLASTIC MATERIAL ON THE CHANGING SURFACE. UNIT SHALL COMPLY WITH ADA REGULATIONS WHEN PROPERLY INSTALLED. BED SHALL HAVE SMOOTH CONCAVE CHANGING AREA WITH A SAFETY STRAP.
UNIT SHALL CONFORM TO ASTM F2285-04(16) STANDARD SAFETY PERFORMANCE SPECIFICATION FOR DIAPER CHANGING TABLES FOR COMMERCIAL USE, ANSI Z35.4 PRODUCT SAFETY SIGNS AND LABELS, EN 12221-2:2008+A1: 2013. UNIT SHALL HAVE A BUILT-IN LINER DISPENSER FOR USE WITH 5-PLY CHEMICAL FREE BIODEGRADABLE BED LINERS, INSTRUCTIONAL GRAPHICS AND SAFETY MESSAGES IN 4 LANGUAGES. UNIT SHALL BE BACKED BY MANUFACTURER'S 5-YEAR LIMITED WARRANTY ON MATERIALS AND WORKMANSHIP AND INCLUDE A PROVISION FOR REPLACEMENT CAUSED BY VANDALISM. COLOR TO BE GREY.
BABY CHANGING STATIONS MUST BE PROPERLY INSTALLED ACCORDING TO THE MANUFACTURER'S INSTRUCTIONS.

SANITARY NAPKIN DISPOSAL:
SURFACE-MOUNTED SANITARY NAPKIN DISPOSAL SHALL BE BY OWNER AND INSTALLED BY CONTRACTOR.

COAT HOOK:
SURFACE-MOUNTED ROBE HOOK SHALL BE TYPE 304 STAINLESS STEEL WITH SATIN FINISH. FLANGE AND SUPPORT ARM SHALL BE 22 GAUGE (0.8MM) AND EQUIPPED WITH A CONCEALED, 18-GAUGE (1.2MM) MOUNTING BRACKET THAT IS SECURED TO A CONCEALED, 19-GAUGE (1.0MM) WALL PLATE WITH A STAINLESS STEEL SETSCREW. CAP SHALL BE 14 GAUGE (2.0MM), WELDED TO THE SUPPORT ARM.

GENERAL NOTES

INTERIOR ELEVATIONS NOTES:

1. REFER TO SHEET A002 FOR MOUNTING HEIGHTS
2. ALL OVERHEAD DUCTS, CONDUITS AND PIPES TO BE KEPT 7'7" MIN. ABOVE FLOOR LEVEL.
3. GC TO PROVIDE CUT SHEETS AND SHOP DRAWINGS FOR PLACEMENT OF ALL TOILET ACCESSORIES.
4. ALL ACCESSORIES TO BE PROVIDED BY GC UNLESS NOTED AS BEING BY OWNER.

REFERENCE KEYNOTES

08 16 13.A00	ALUMINUM DOOR AND FRAME
09 65 13.A00	RESILIENT WALL BASE
10 21 13.19.A00	PLASTIC TOILET COMPARTMENT
10 21 13.19.C00	PLASTIC URINAL SCREEN
10 28 00.N00	HOT AIR HAND DRYER
22 40 00.A00	FLOOR DRAIN, SEE PLUMBING DRAWINGS
22 40 00.A00	PLUMBING FIXTURES, SEE PLUMBING DRAWINGS
22 47 00.A00	DRINKING FOUNTAIN, SEE PLUMBING DRAWINGS

SHEET KEYNOTES

30	SOAP DISPENSER PROVIDED BY OWNER, INSTALLED BY GC.
31	TOILET PAPER DISPENSER PROVIDED BY OWNER, INSTALLED BY G.C.
33	SANITARY NAPKIN DISPENSER, BY OWNER INSTALLED BY G.C.
35	42" LONG 1 1/2" DIAMETER GRAB BAR, SATIN FINISHED. BOBRICK NO (B-6806-99 X 18)
36	36" LONG 1 1/2" DIAMETER GRAB BAR BOBRICK NO (B-6809-99 X 36)
37	16" LONG 1 1/2" DIAMETER GRAB BAR BOBRICK NO (B-6809-99 X 42)
38	K8300 BABY CHANGING STATION, KONA-BE40
39	WELDED-FRAME MIRROR 18"X30", BOBRICK NO 290 1830
40	FIXED POSITION TILT-MIRROR, BOBRICK NO 293 1830
41	SURFACE MOUNTED SANITARY NAPKIN DISPOSAL PROVIDED BY OWNER, INSTALLED BY GC
42	SURFACE MOUNTED COAT HOOK, INSTALL ON INSIDE FACE OF STALL DOOR.
43	HAND DRYER, TYSON AIRBLADE V, HJ02, 120 V, SPRAYED NICKEL

ARCHITECT/LANDSCAPE
WEBER MURPHY FOX

4330 WEST LAKE ROAD
ERIE PA 16565
PHONE: 814-803-1505
E-MAIL: wmf@wmf-inc.com
www.wmf-inc.com

CIVIL

K&W

2301 N FRONT STREET, SUITE 200
HARRISBURG, PA 17110
PHONE: 717-630-2855
E-MAIL: mmp@kandwengineers.com
www.kandwengineers.com

MEP ENGINEERING

BARTON ASSOCIATES

3002 NORTH BUILDING, 221 W PHILADELPHIA ST.
PHILADELPHIA, PA 19107
PHONE: 215-572-2285
E-MAIL: barton@barton.com
www.barton.com


STRUCTURAL

DIVINEY & ASSOCIATES

315 FRONT STREET, SUITE 104
HOLLANDSBURG, PA 16848
PHONE: 814-317-5837
E-MAIL: diviney@DAStructures.com
www.dastuctures.com

	01-22-2023	BID SET
	12-06-2023	REVISED DRAWINGS
	10-04-2023	BID SET
	09-27-2023	PERMIT SET
	09-06-2023	CD SUBMISSION
MARK	DATE	DESCRIPTION

KEY PLAN:

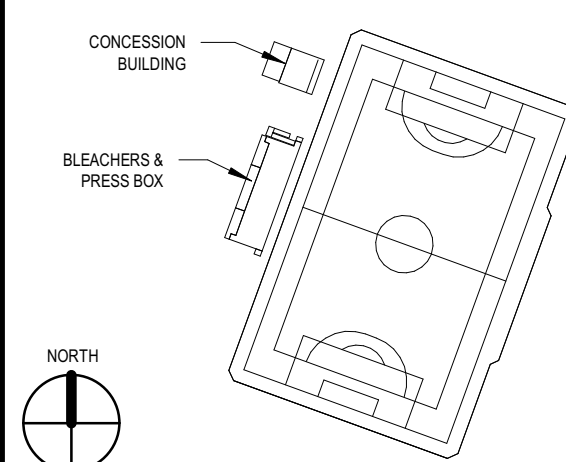

PROJECT TITLE:

**STADIUM SEATING &
RESTROOMS BLDG**
PENN STATE UNIVERSITY HARRISBURG CAMPUS
777 W Harrisburg Pike, Middletown, PA 17057

PSU BUILDING NUMBER: 0985095

PSU PROJECT NUMBER: 00-08713.00

PROJECT NUMBER: 2022.138.00

PROJECT PHASE: CONSTRUCTION DOCUMENTS

**LARGE SCALE PLANS &
INTERIOR ELEVATIONS**

DRAWN BY: Author

CHECKED BY: Checker

COPYRIGHT © WEBER MURPHY FOX INC. 2022

DRAWING NO.

AE401